Inyadda Drive, Manyana NSW 2539

Landscape Subdivision Streetscape Development Application

Drawing Schedule

Drawing Number	Drawing Title	Scale
L-000	Coversheet & Plant Schedule	N/A
L-100	Landscape Site Plan	1:1500
L-101	Landscape Plan 1 of 5	1:500
L-102	Landscape Plan 2 of 5	1:500
L-103	Landscape Plan 3 of 5	1:500
L-104	Landscape Plan 4 of 5	1:500
L-105	Landscape Plan 5 of 5	1:500
L-106	Landscape Bio Basin Plan	1:150
L-107	Community Park	1:100
L-207	Planting Plan - Community Park	1:100
L-500	Landscape Specification Notes & Typical Street Tree Sections	1:10 & 1:20
L-501	Landscape Details	1:10
L-502	Landscape Typical Sections	1::10



---- SITE BOUNDARY

Inyadda	a Drive Subdivision				SI No: SS22-4882	
Abbrev.	Botanic Name	Common Name	Mature Size H x W	Pot Size	Density	Qty
PLANTING	SCHEDULE					
STREET TRE	EES					
Вс	Backhousia citriodora	Lemon Scented Myrtle	8.0 x 4.0	100L	As Shown	37
Ca	Cupaniopsis anacardioides	Tuckeroo	6.0 x 10.0	100L	As Shown	35
HtR	Hibiscus tiliaceus 'Rubra'	Red Cottonwood	7.0 x 5.0	100L	As Shown	133
LiN	Lagerstroemia indica 'Natchez'	White Crepe Myrtle	8.0 x 6.0	100L	As Shown	90
MI	Melaleuca linariifolia	Snow In Summer	8.0 x 6.0	100L	As Shown	102
PcC	Pyrus calleryana 'Chanticleer'	Ornamental Pear	11.0 x 6.0	100L	As Shown	104
TIL	Tristaniopsis laurina	Watergum	15.0 x 6.0	100L	As Shown	142
Wf	Waterhousia floribunda	Weeping Lilly Pilly	10.0 x 6.0	100L	As Shown	22
BIO BASIN						
MATRIX 1						457m ²
Са	Carex appressa	Tall Sedge	1.0 x 1.0	Viro Tube	8/m²	914 (25%)
Dr	Dianella revoluta	Blueberry Lilly	1.0 x 1.0	Viro Tube	8/m²	914 (25%)
LI	Lomandra longifolia	Mat Rush	1.0 x 1.0	Viro Tube	$8/m^2$	914 (25%)
Pl	Poa labillardieri	Common Tussock Grass	1.0 x 0.6	Viro Tube	8/m ²	914 (25%)
MATRIX 2						397m²
Bt	Baloskion tetraphyllum	Tassel Cord Rush	1.8 x 1.5	Viro Tube	8/m²	953 (30%)
Ju	Juncus usitatus	Common Rush	1.2 x 1.5	Viro Tube	8/m²	1112 (35%
Pa	Pennisetum alopecuroides	Swamp Foxtail	1.5 x 1.0	Viro Tube	8/m²	1112 (35%
TURF VERG	GE					
	Stenotaphrum secundatum	Sir Walter Soft-leaf Buffalo				19879m²

Inyadd	la Drive Subdivision	SI No: SS22-4882				
Abbrev.	Botanic Name	Common Name	Mature Size H x W	Pot Size	Density	Qty
	ARK INDICATIVE PLANTING SCHEDULE					
TREES						
Ac	Angophora costata	Smoothbarked Apple	20.0 x 12.0	100L	As Shown	2
Bi	Banksia integrifolia	Coast Banskia	3.0 x2.0	100L	As Shown	3
Ва	Brachychiton acerifolius	Illawarra Flame Tree	15.0 x 10.0	100L	As Shown	2
Jm	Jacaranda mimosifolia	Jacaranda	15.0 x 8.0	100L	As Shown	1
TIL	Tristaniopsis laurina 'Luscious'	Water Gum	8.0 x 4.0	100L	As Shown	1
LiT	Lagerstroemia indica 'Tuscarora'	Pink Crepe Mytle	6.0 x 5.0	100L	As Shown	2
Wf	Waterhousia floribunda	Weeping Lilly Pilly	10.0 x 6.0	100L	As Shown	2
ACCENTS	& SHRUBS					
AsM	Acmena smithii 'Minor'	Lilly Pilly	3.0 x 2.0	200mm	As Shown	103
Bs	Banksia spinulosa	Hills Banksia	3.0 x 2.0	200mm	As Shown	27
CWA	Callistemon 'White Anzac'	Bottlebrush	1.5 x 1.5	200mm	As Shown	51
Са	Correa alba	Native Fuchsia	1.5 x 1.5	200mm	As Shown	99
CDB	Correa 'Dusky Bells'	Native Fuchsia	0.5 x 1.0	200mm	As Shown	31
De	Doryanthes excelsa	Gymea Lily	2.0 x 2.0	200mm	As Shown	80
Dv	Dodonaea viscosa	Hop Bush	3.0 x 1.5	200mm	As Shown	9
Gr	Grevillea rosmarinifolia	Rosemary Grevillea	2.5 x 2.5	200mm	As Shown	40
LIF	Leptospermum laevigatum Foreshore	Dwarf Coastal Tea Tree	0.5 x 1.0	200mm	As Shown	61
PBB	Phormium Bronze Baby	Dwarf Flax	1.0 x 1.0	200mm	As Shown	69
ROP	Rhapiolepsis indica 'Oriental Pearl'	Indian Hawthorn	1.5 x 1.5	200mm	As Shown	141
Ro	Rosmarinus officinalis	Rosemary Grevillea	1.2 x 1.0	200mm	As Shown	12
WfN	Westringia fruticosa 'Naringa'	Grey Box	1.0 x 1.0	200mm	As Shown	127
GRASSES -	& GROUNDCOVERS					
CDF	Chrysocephalum apiculatum 'Desert Flame'	Everlasting Daisy	0.3 x 0.5	140mm	5/m²	154
DcS	Dianella citriodora 'Seaspray'	Spreading Flax Lily	1.0 x 1.0	140mm	5/m²	109
Hs	Hibbertia scandens	Guinea Flower	0.1 x 0.2	140mm	5/m²	54
LIT	Lomandra longifolia 'Tanika'	Tanika	0.5 x 0.6	140mm	5/m ²	432
Мр	Myoporum parvifolium purpurea	Creeping Boobialla	0.3 x 3.0	140mm	5/m ²	220
PPL	Pennisetum alopecuroides 'Purple Lea'	Swamp Foxtail Grass	1.5 x 0.8	140mm	5/m ²	160
TURF						
	Stenotaphrum secundatum	Sir Walter Soft-leaf Buffalo				1081 n


© 2022 Site Image (NSW) Pty Ltd ABN 44 801 262 380 as agent for Site Image NSW Partnership. All rights reserved. This drawing is copyright and shall not be reproduced or copied in any form or by any means (graphic, electronic or mechanical including photocopy) without the written permission of Site Image (NSW) Pty Ltd Any license, expressed or implied, to use this document for any purpose what so ever is restricted to the terms of the written agreement between Site Image (NSW) Pty Ltd and the instructing

The contractor shall check and verify all work on site (including work by others) before commencing the landscape installation. Any discrepancies are to be reported to the Project Manager or Landscape Architect prior to commencing work. Do not scale this drawing. Any required dimensions not shown shall be referred to the Landscape Architect for confirmation.

For Approval	PH	RS
Response to Council RFI	NP	RS
For Approval	NP	RS
Preliminary	NP	RS

14.07.2023 22.04.2022 14.03.2022 02.03.2022

Key Plan

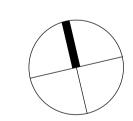

Heir Asquith

Inyadda Drive, Manyana NSW 2539

SITE IMAGE

Level 1, 3-5 Baptist Street Redfern NSW 2016 Australia Tel: (61 2) 8332 5600 www.siteimage.com.au




DEVELOPMENT APPLICATION

Drawing Name Cover Sheet

Site Image (NSW) Pty Ltd ABN 44 801 262 380

SS22-4882

L-000 D

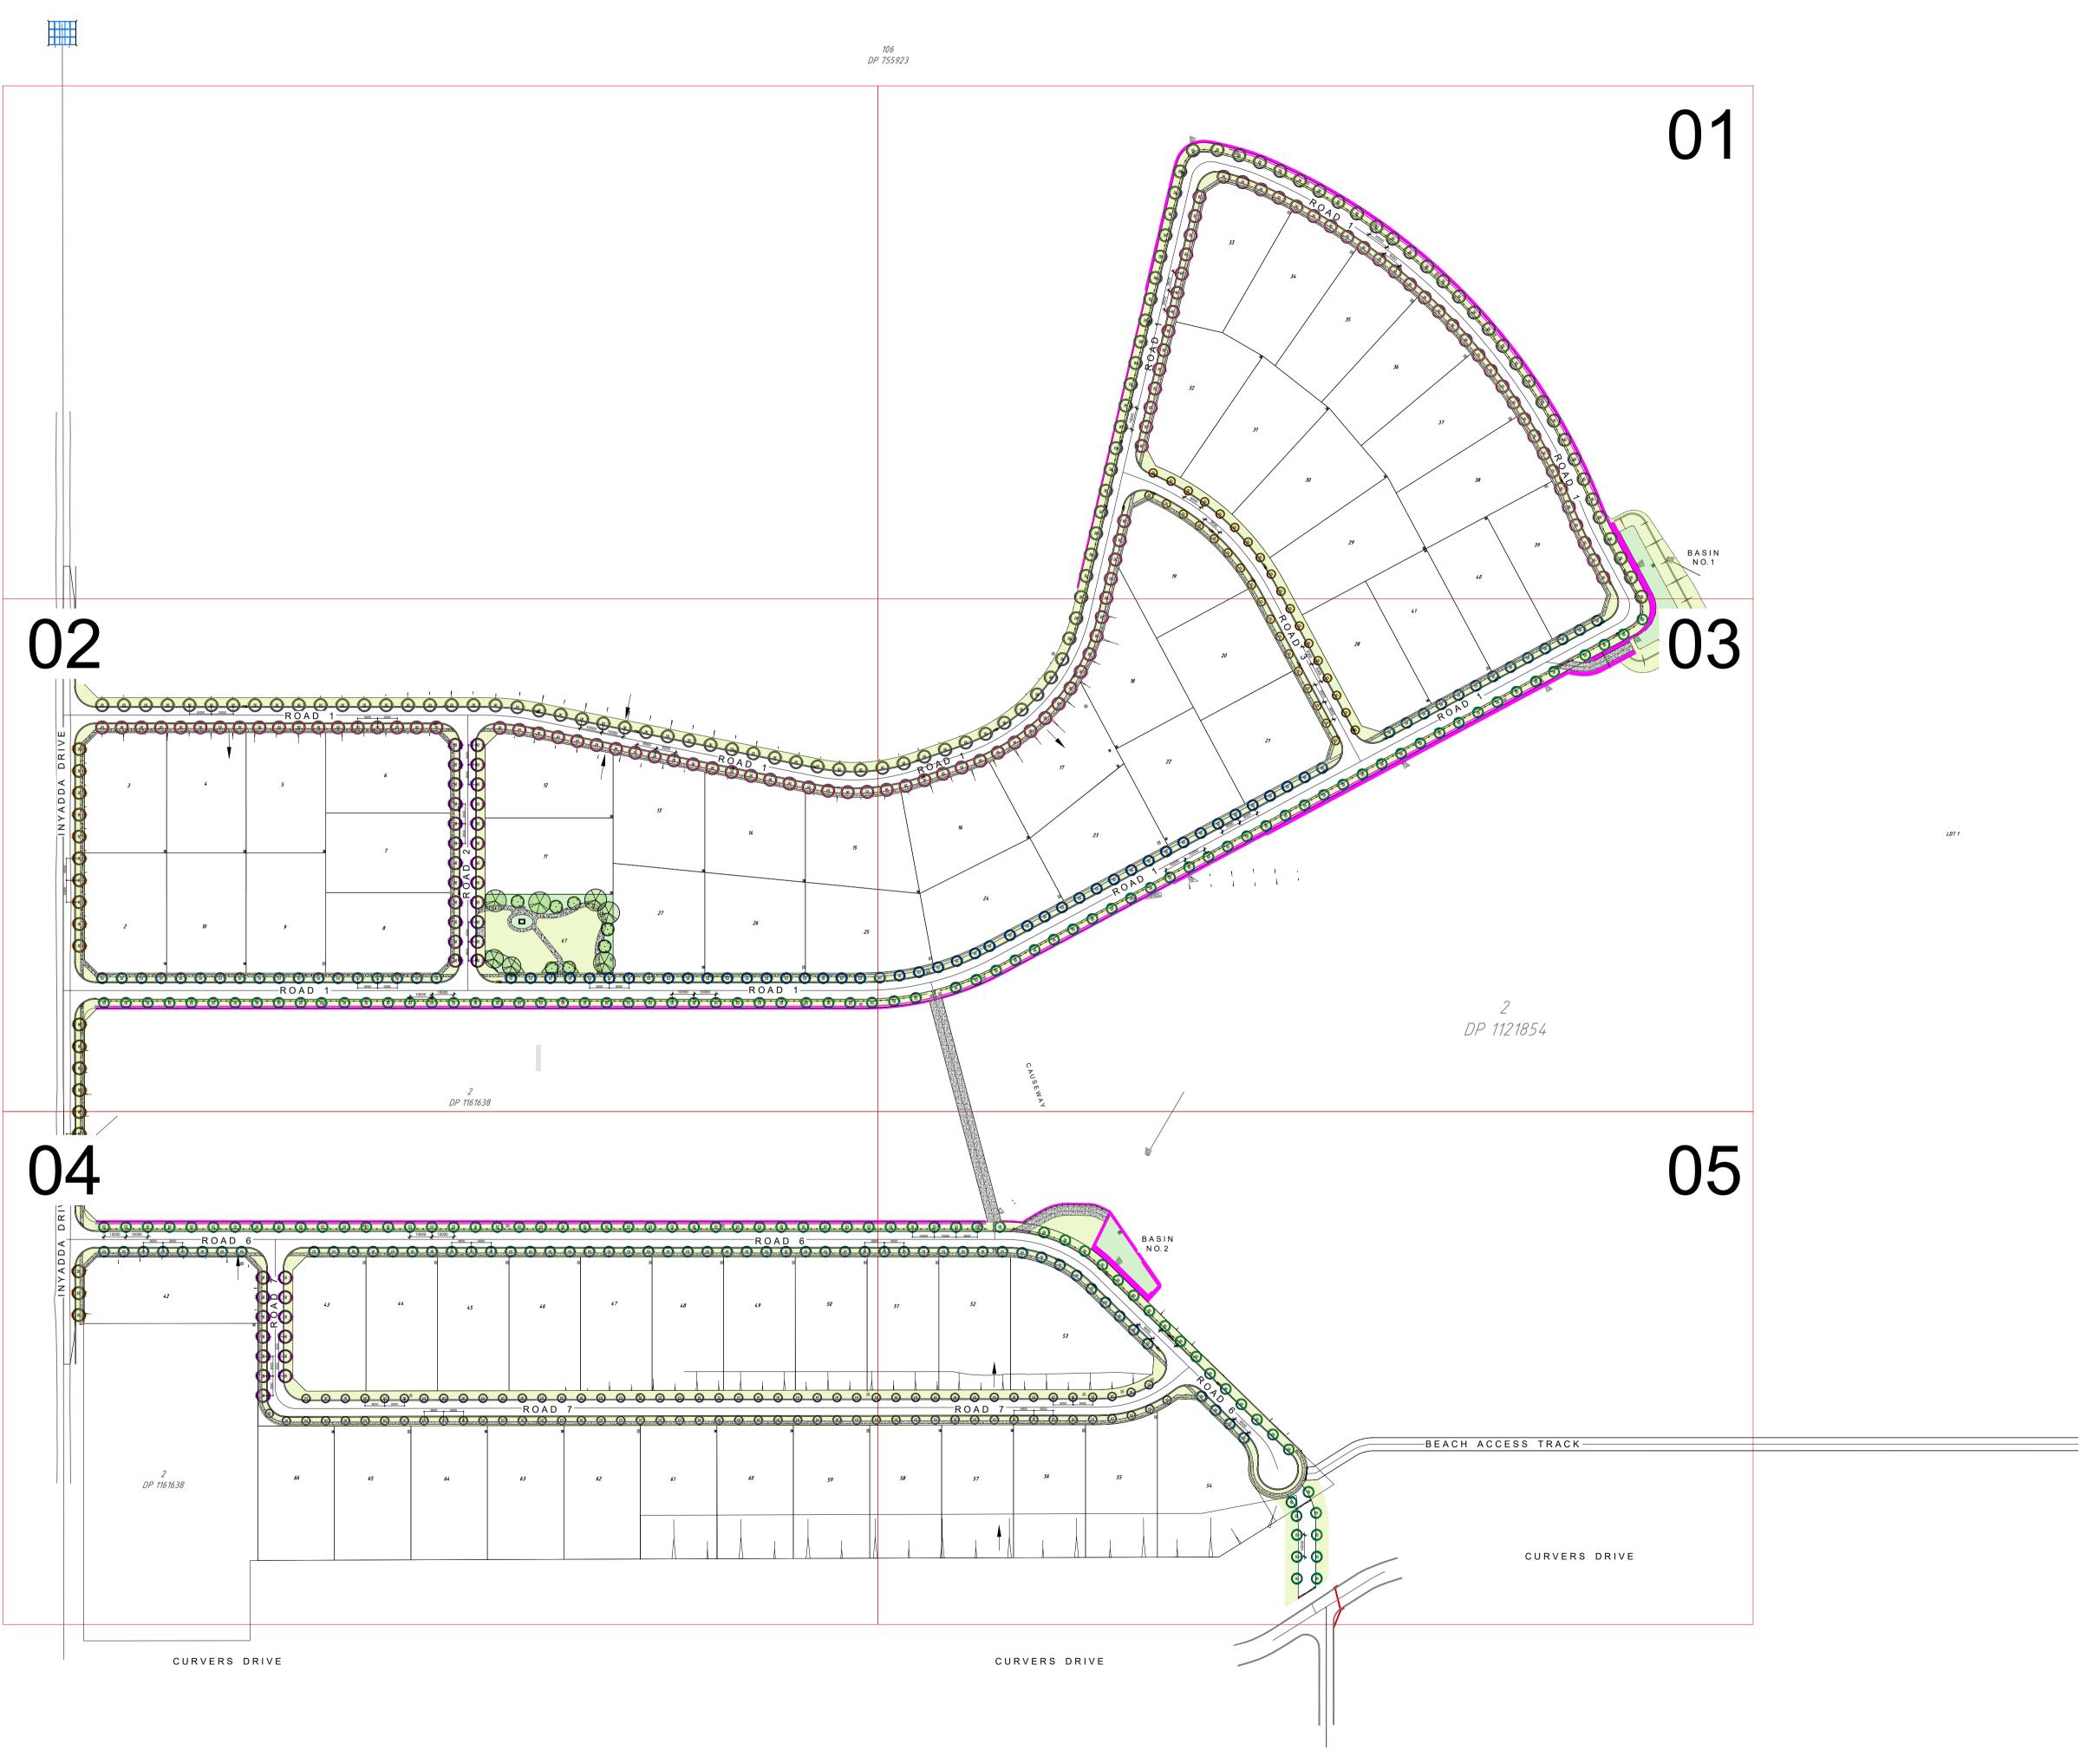

© 2022 Site Image (NSW) Pty Ltd ABN 44 801 262 380 as agent for Site Image NSW Partnership. All rights reserved. This drawing is copyright and shall not be reproduced or copied in any form or by any means (graphic, electronic or mechanical including photocopy) without the written permission of Site Image (NSW) Pty Ltd Any license, expressed or implied, to use this document for any purpose what so ever is restricted to the terms of the written agreement between Site Image (NSW) Pty Ltd and the instructing

The contractor shall check and verify all work on site (including work by others) before commencing the landscape installation. Any discrepancies are to be reported to the Project Manager or Landscape Architect prior to commencing work. Do not scale this drawing. Any required dimensions not shown shall be referred to the Landscape Architect for confirmation.

D For Approval PH RS 14.07.2023 Response to Council RFI NP RS 22.04.2022 B For Approval NP RS 14.03.2022 NP RS 02.03.2022 A Preliminary Drawn Check Date Issue Revision Description

Backhousia myrtifolia Grey Myrtle - 8.0 x 4.0 (Refer Planting Schedule) Cupaniopsis anacardioides Tuckeroo - 6.0 x 10.0 (Refer Planting Schedule) Hibiscus tiliaceus 'Rubra' Red Cottonwood - 7.0 x 5.0 (Refer Planting Schedule) Lagerstroemia indica 'Natchez' White Crepe Myrtle - 8.0 x 6.0 (Refer Planting Schedule) Melaleuca linariifolia

> Snow In Summer - 8.0 x 6.0 (Refer Planting Schedule) Tristaniopsis laurina Watergum- 15.0 x 6.0 (Refer Planting Schedule) Waterhousia floribunda Weeping Lilly Pilly - 10.0 x 6.0 (Refer Planting Schedule)

> > Ornamental Pear - 10.0 x 6.0

(Refer Detail & Specification)

Pyrus calleryana 'Chanticleer'


(Refer Planting Schedule) Concrete Footpath (Refer Civil Details)

Turf Verge

Bio Basin Planting Matrix Type 1 (Refer Planting Schedule) 🗸 Bio Basin

Planting Matrix Type 2
(Refer Planting Schedule)

Key Plan

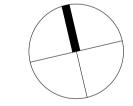

Heir Asquith

Inyadda Drive,

Manyana NSW 2539

SITE IMAGE

Level 1, 3-5 Baptist Street Redfern NSW 2016 Australia Tel: (61 2) 8332 5600

> www.siteimage.com.au Site Image (NSW) Pty Ltd ABN 44 801 262 380

Fax: (61 2) 9698 2877





DEVELOPMENT APPLICATION


Drawing Name Site Plan

SS22-4882

L-100 D

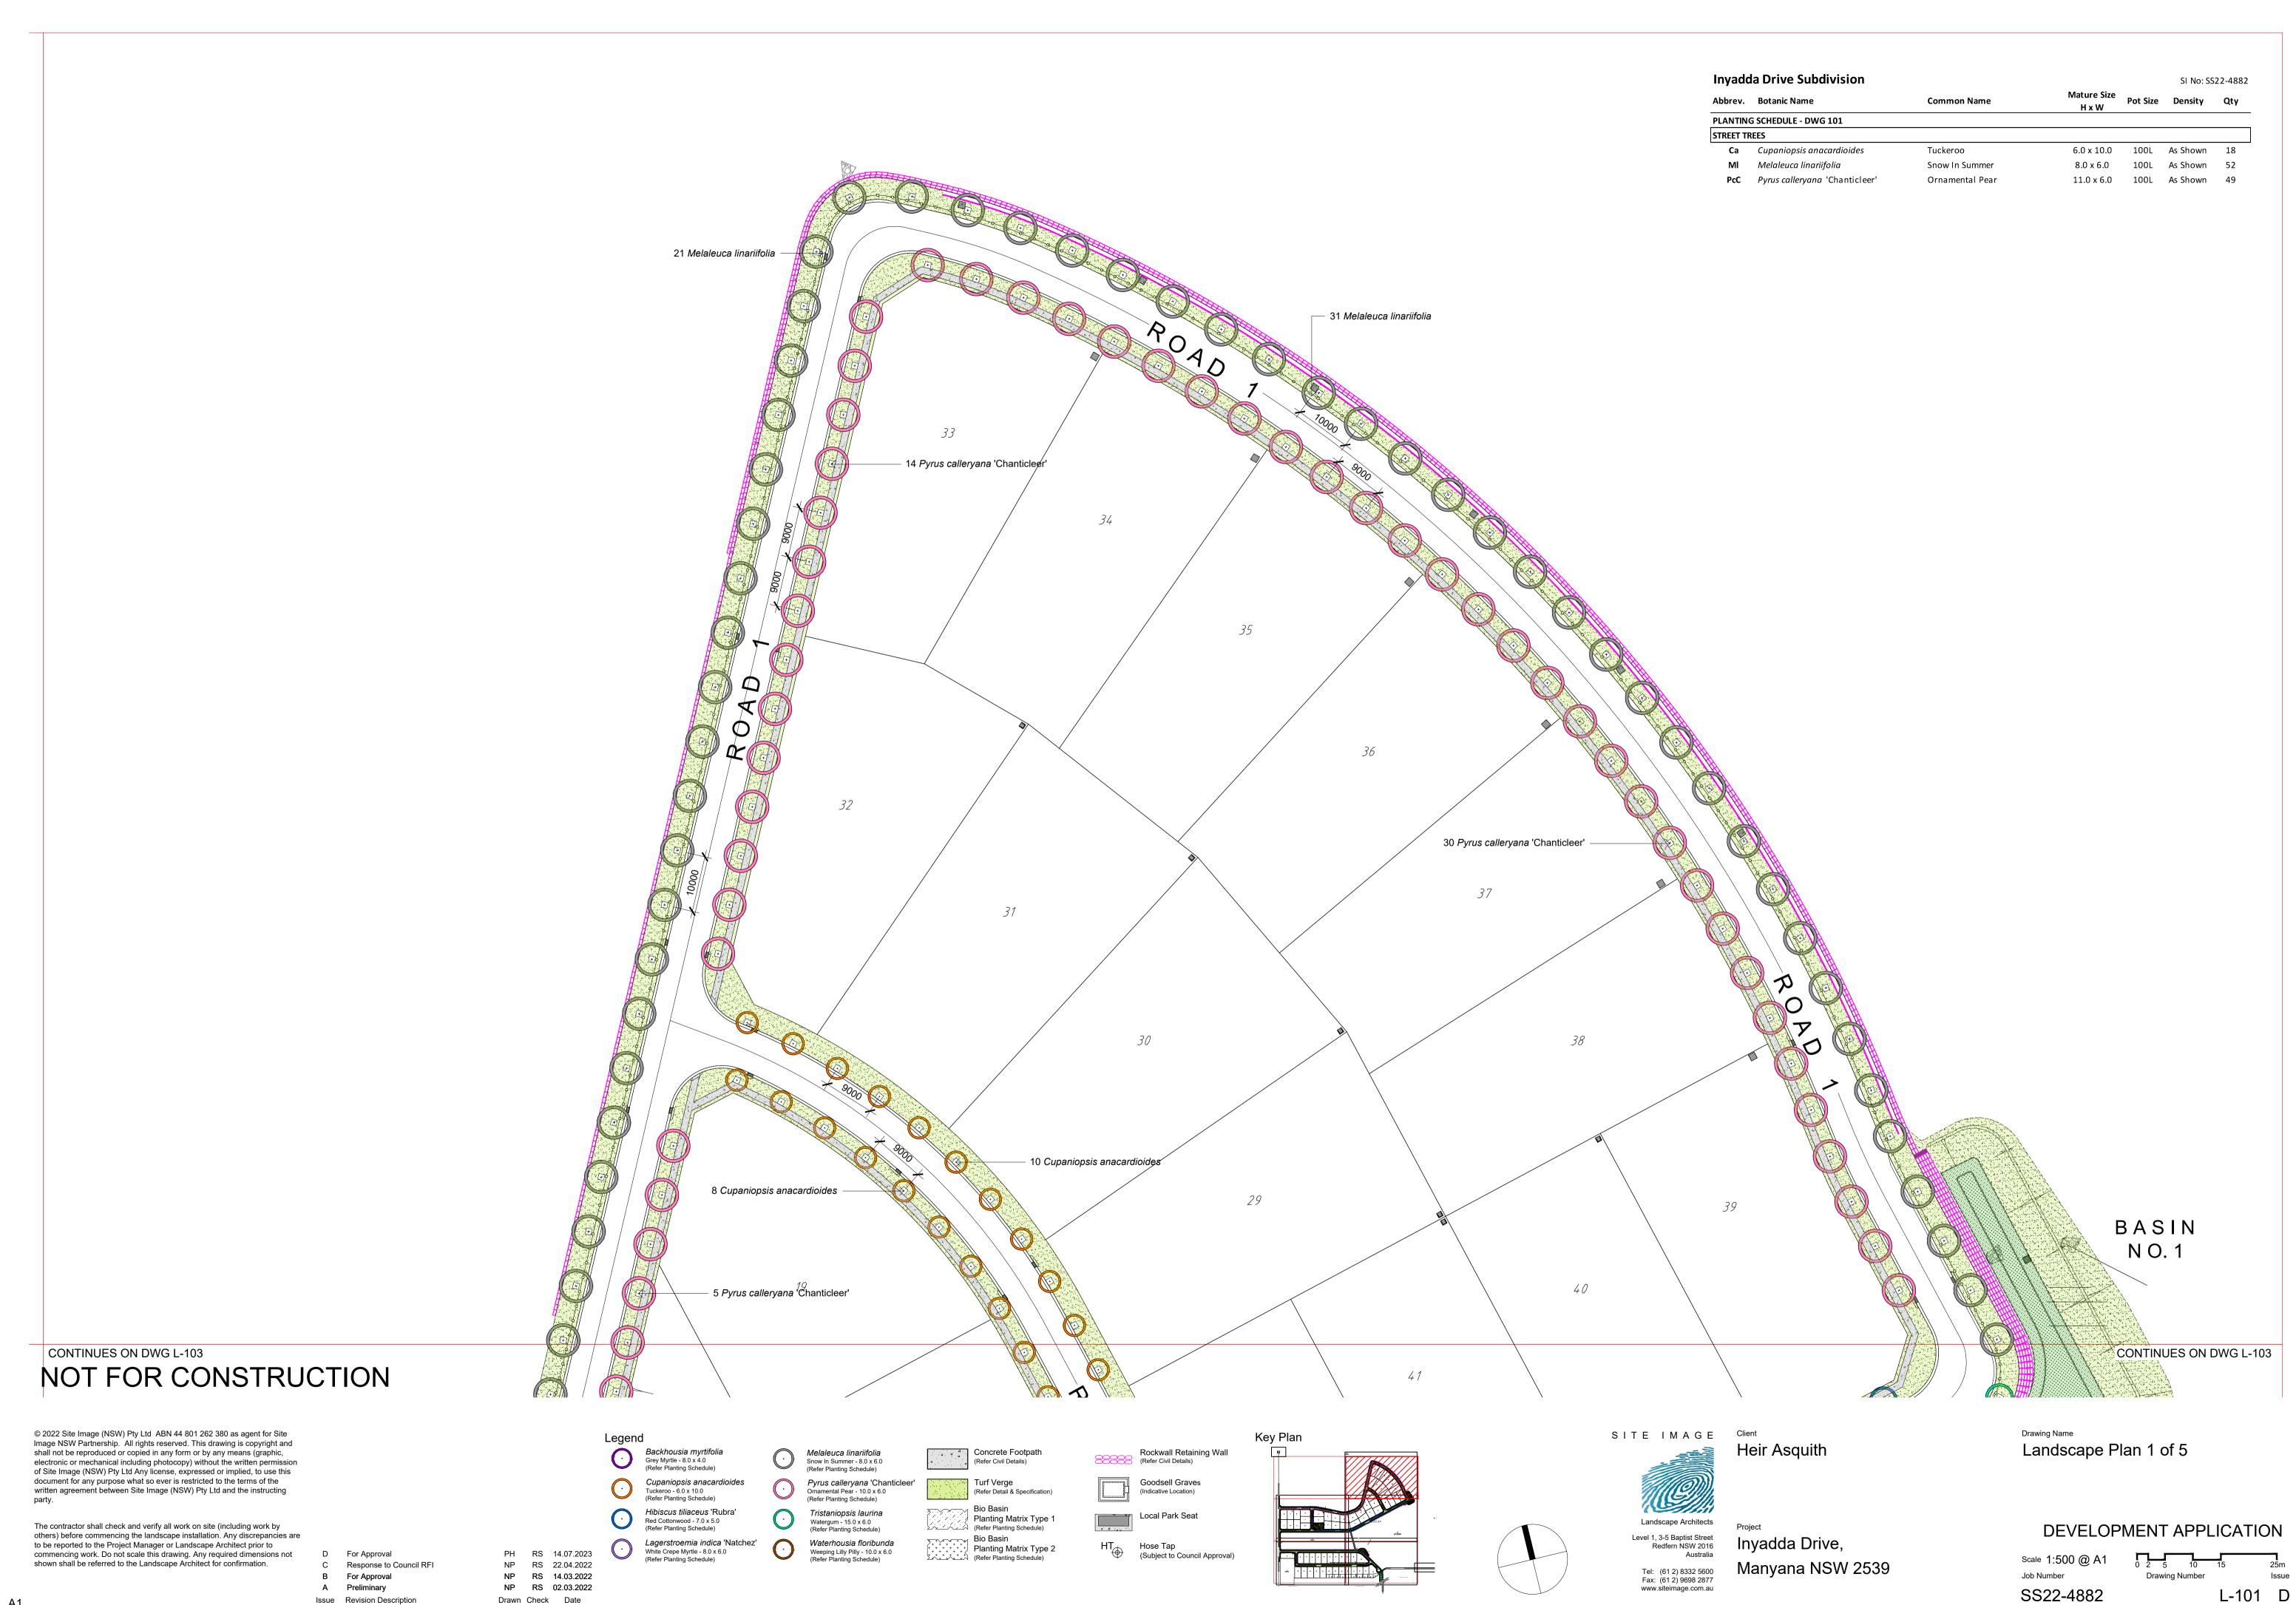

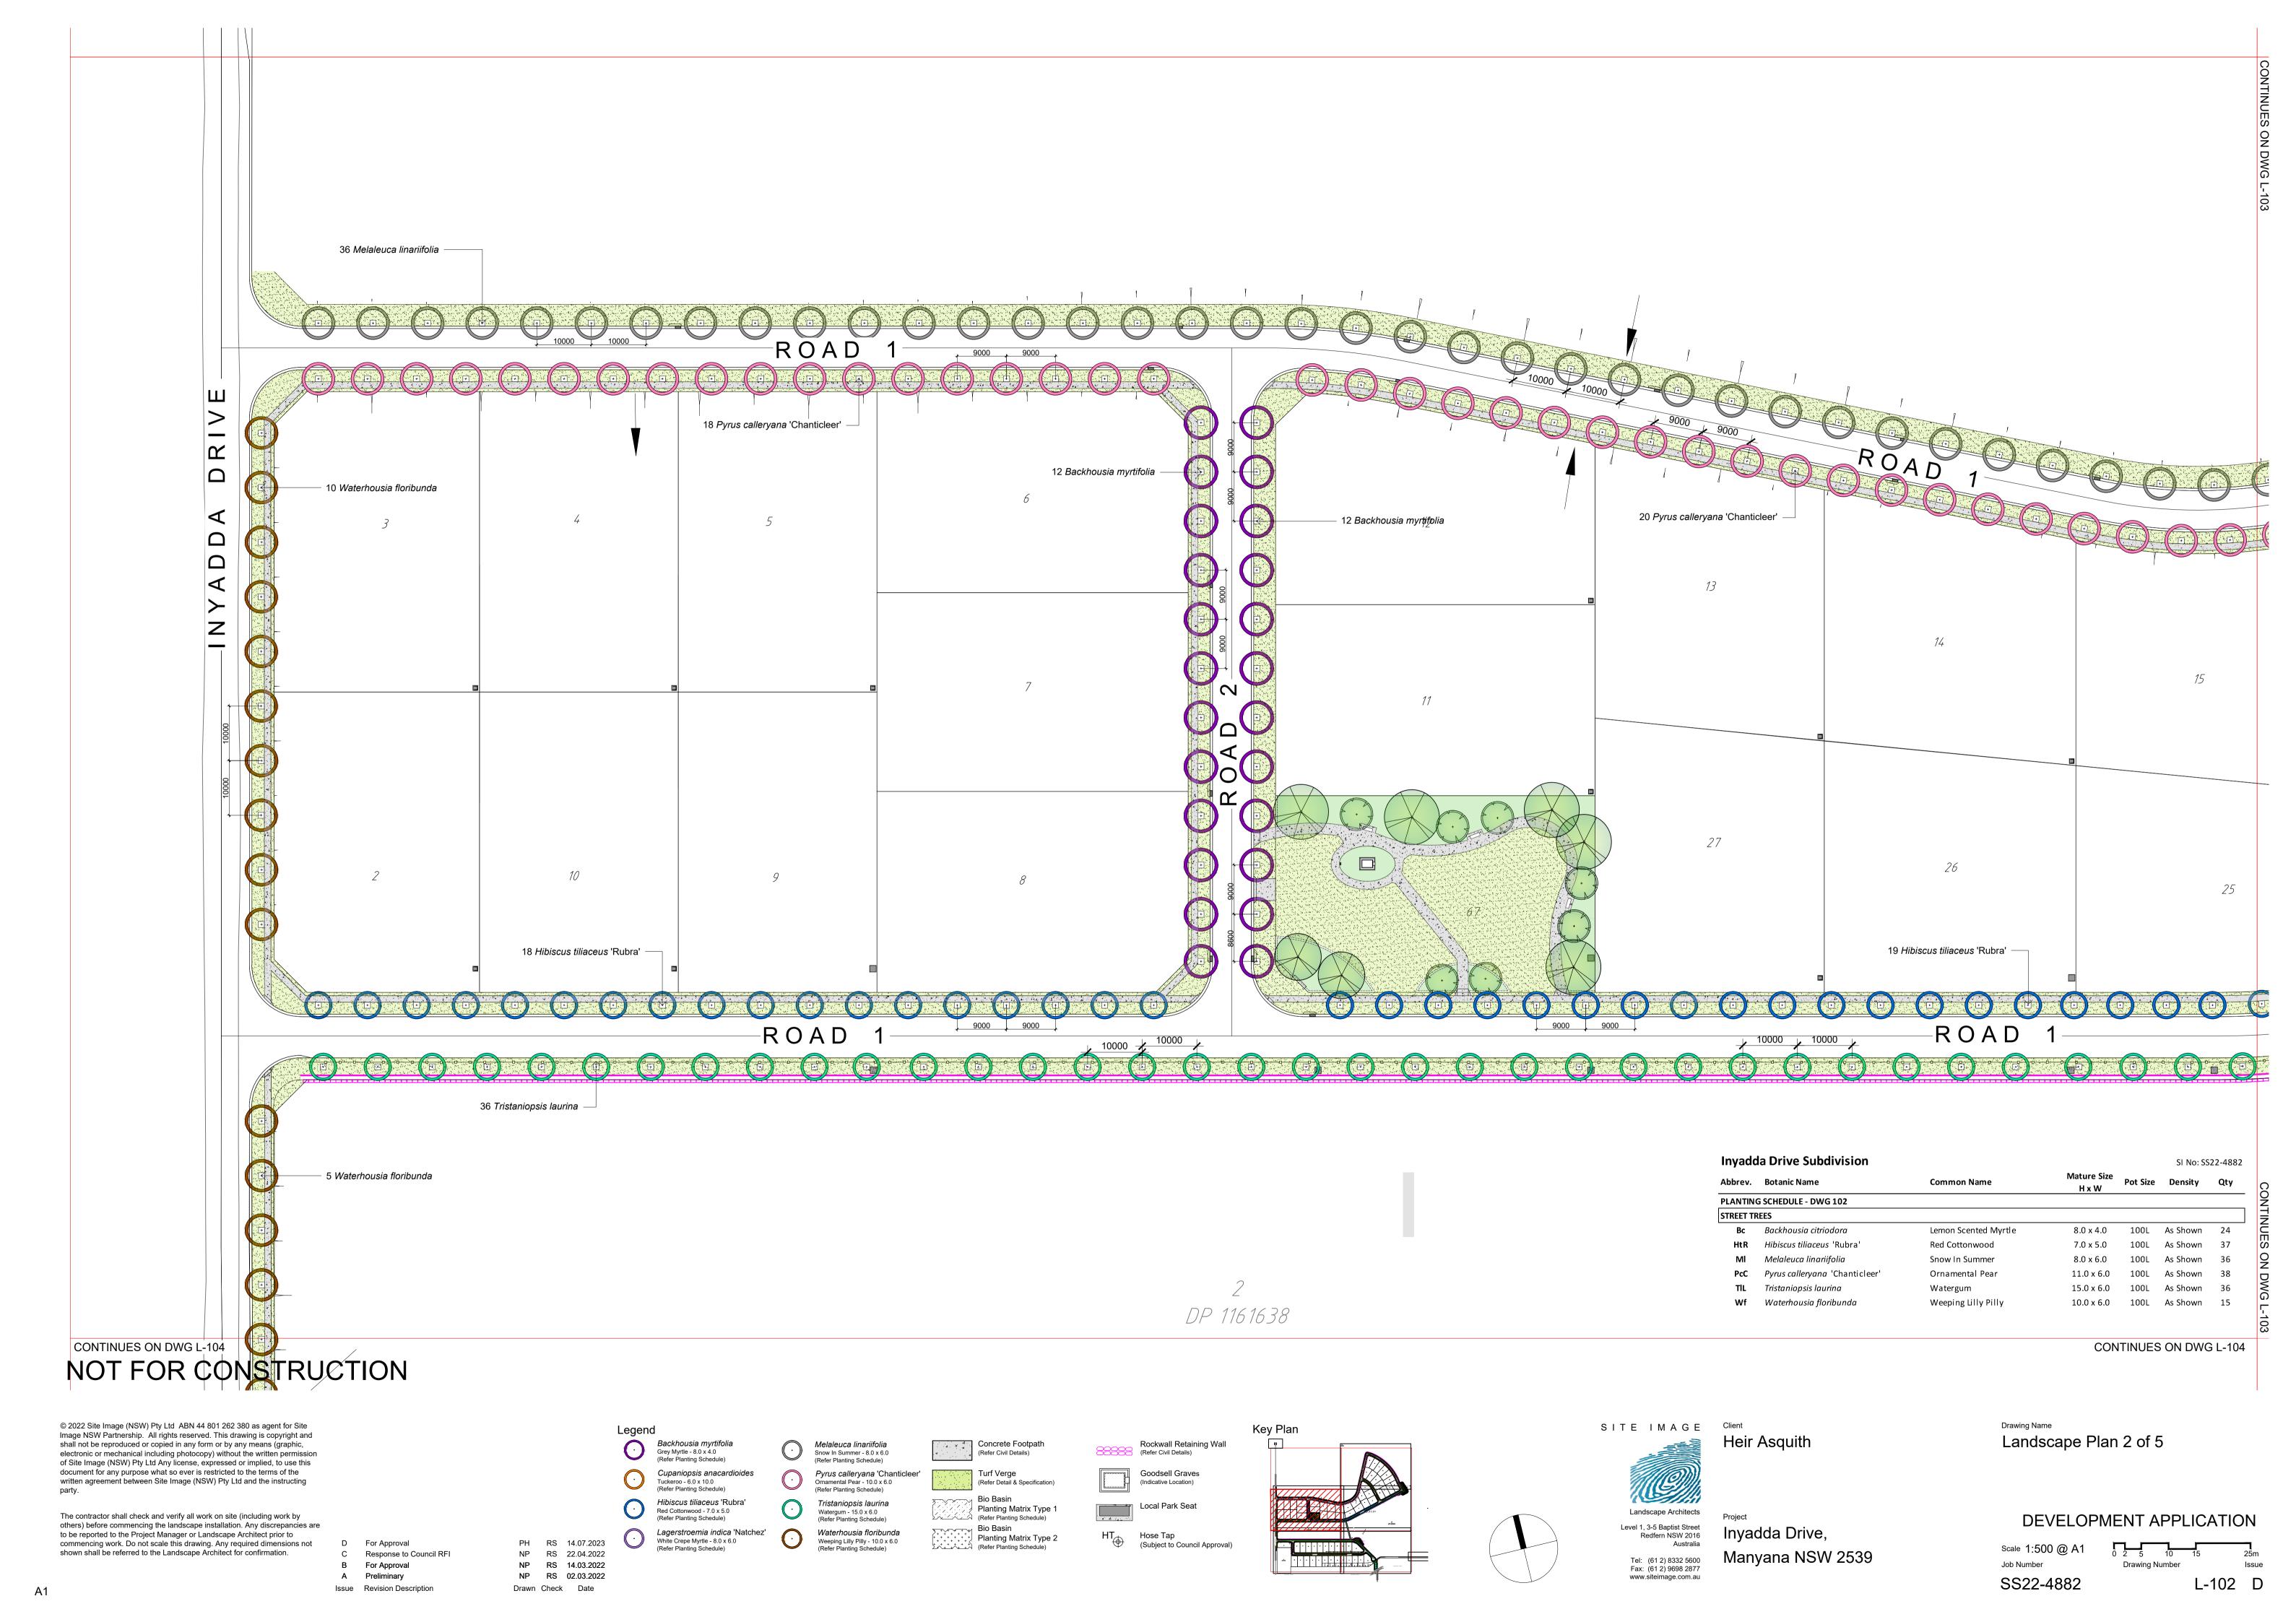

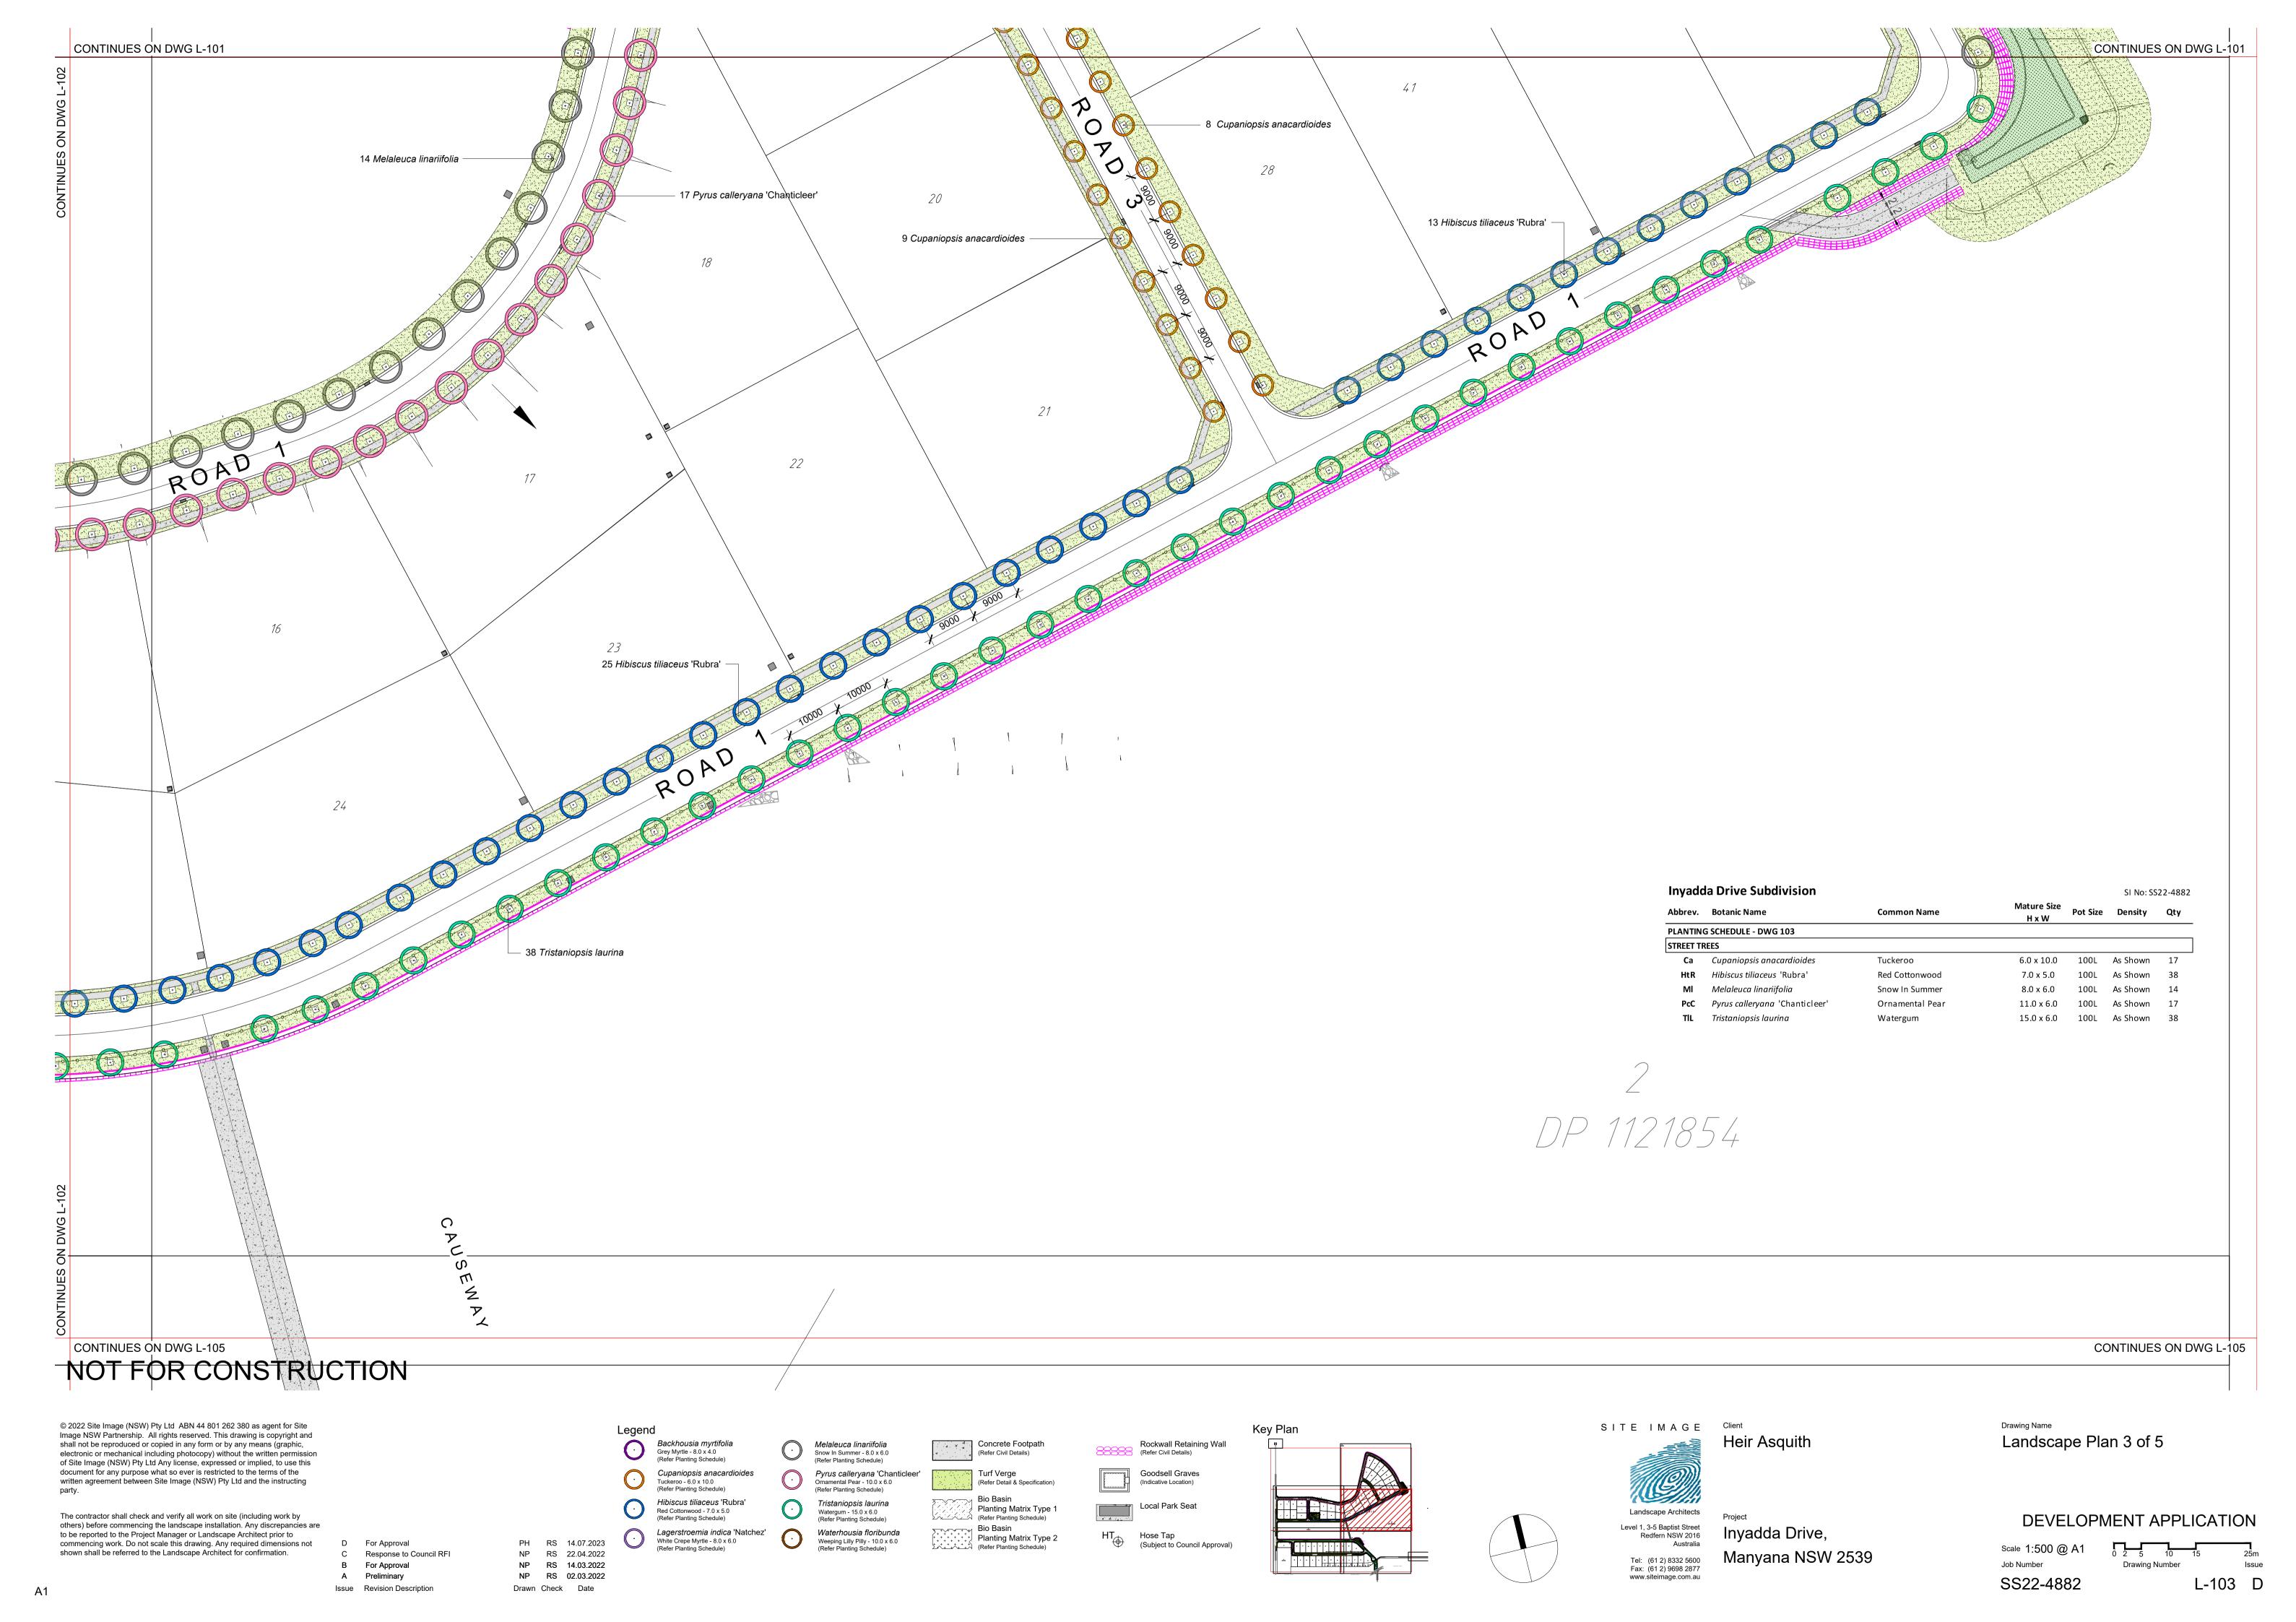

© 2022 Site Image (NSW) Pty Ltd $\,$ ABN 44 801 262 380 as agent for Site Image NSW Partnership. All rights reserved. This drawing is copyright and shall not be reproduced or copied in any form or by any means (graphic, electronic or mechanical including photocopy) without the written permission of Site Image (NSW) Pty Ltd Any license, expressed or implied, to use this document for any purpose what so ever is restricted to the terms of the written agreement between Site Image (NSW) Pty Ltd and the instructing

The contractor shall check and verify all work on site (including work by others) before commencing the landscape installation. Any discrepancies are to be reported to the Project Manager or Landscape Architect prior to commencing work. Do not scale this drawing. Any required dimensions not shown shall be referred to the Landscape Architect for confirmation.

For Approval Response to Council RFI B For Approval A Preliminary

PH RS 14.07.2023 NP RS 22.04.2022 NP RS 14.03.2022 NP RS 02.03.2022 Drawn Check Date Issue Revision Description

Backhousia myrtifolia Grey Myrtle - 8.0 x 4.0 (Refer Planting Schedule) Cupaniopsis anacardioides Tuckeroo - 6.0 x 10.0 (Refer Planting Schedule) Hibiscus tiliaceus 'Rubra' Red Cottonwood - 7.0 x 5.0 (Refer Planting Schedule) Lagerstroemia indica 'Natchez' White Crepe Myrtle - 8.0 x 6.0

Melaleuca linariifolia Snow In Summer - 8.0 x 6.0 (Refer Planting Schedule) Ornamental Pear - 10.0 x 6.0 (Refer Planting Schedule) Tristaniopsis laurina Watergum - 15.0 x 6.0

Waterhousia floribunda


Weeping Lilly Pilly - 10.0 x 6.0 (Refer Planting Schedule)


Concrete Footpath Pyrus calleryana 'Chanticleer'

Turf Verge (Refer Detail & Specification) Bio Basin Planting Matrix Type 1 (Refer Planting Schedule) Planting Matrix Type 2 (Refer Planting Schedule)

(Refer Civil Details)

Rockwall Retaining Wall (Refer Civil Details) Goodsell Graves (Indicative Location) Local Park Seat HT Hose Tap
(Subject to Council Approval)

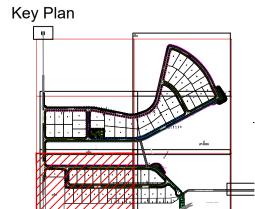

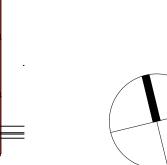



Tel: (61 2) 8332 5600


Fax: (61 2) 9698 2877


Heir Asquith

DEVELOPMENT APPLICATION Scale 1:500 @ A1 Manyana NSW 2539

Job Number **Drawing Number** SS22-4882

L-104 D

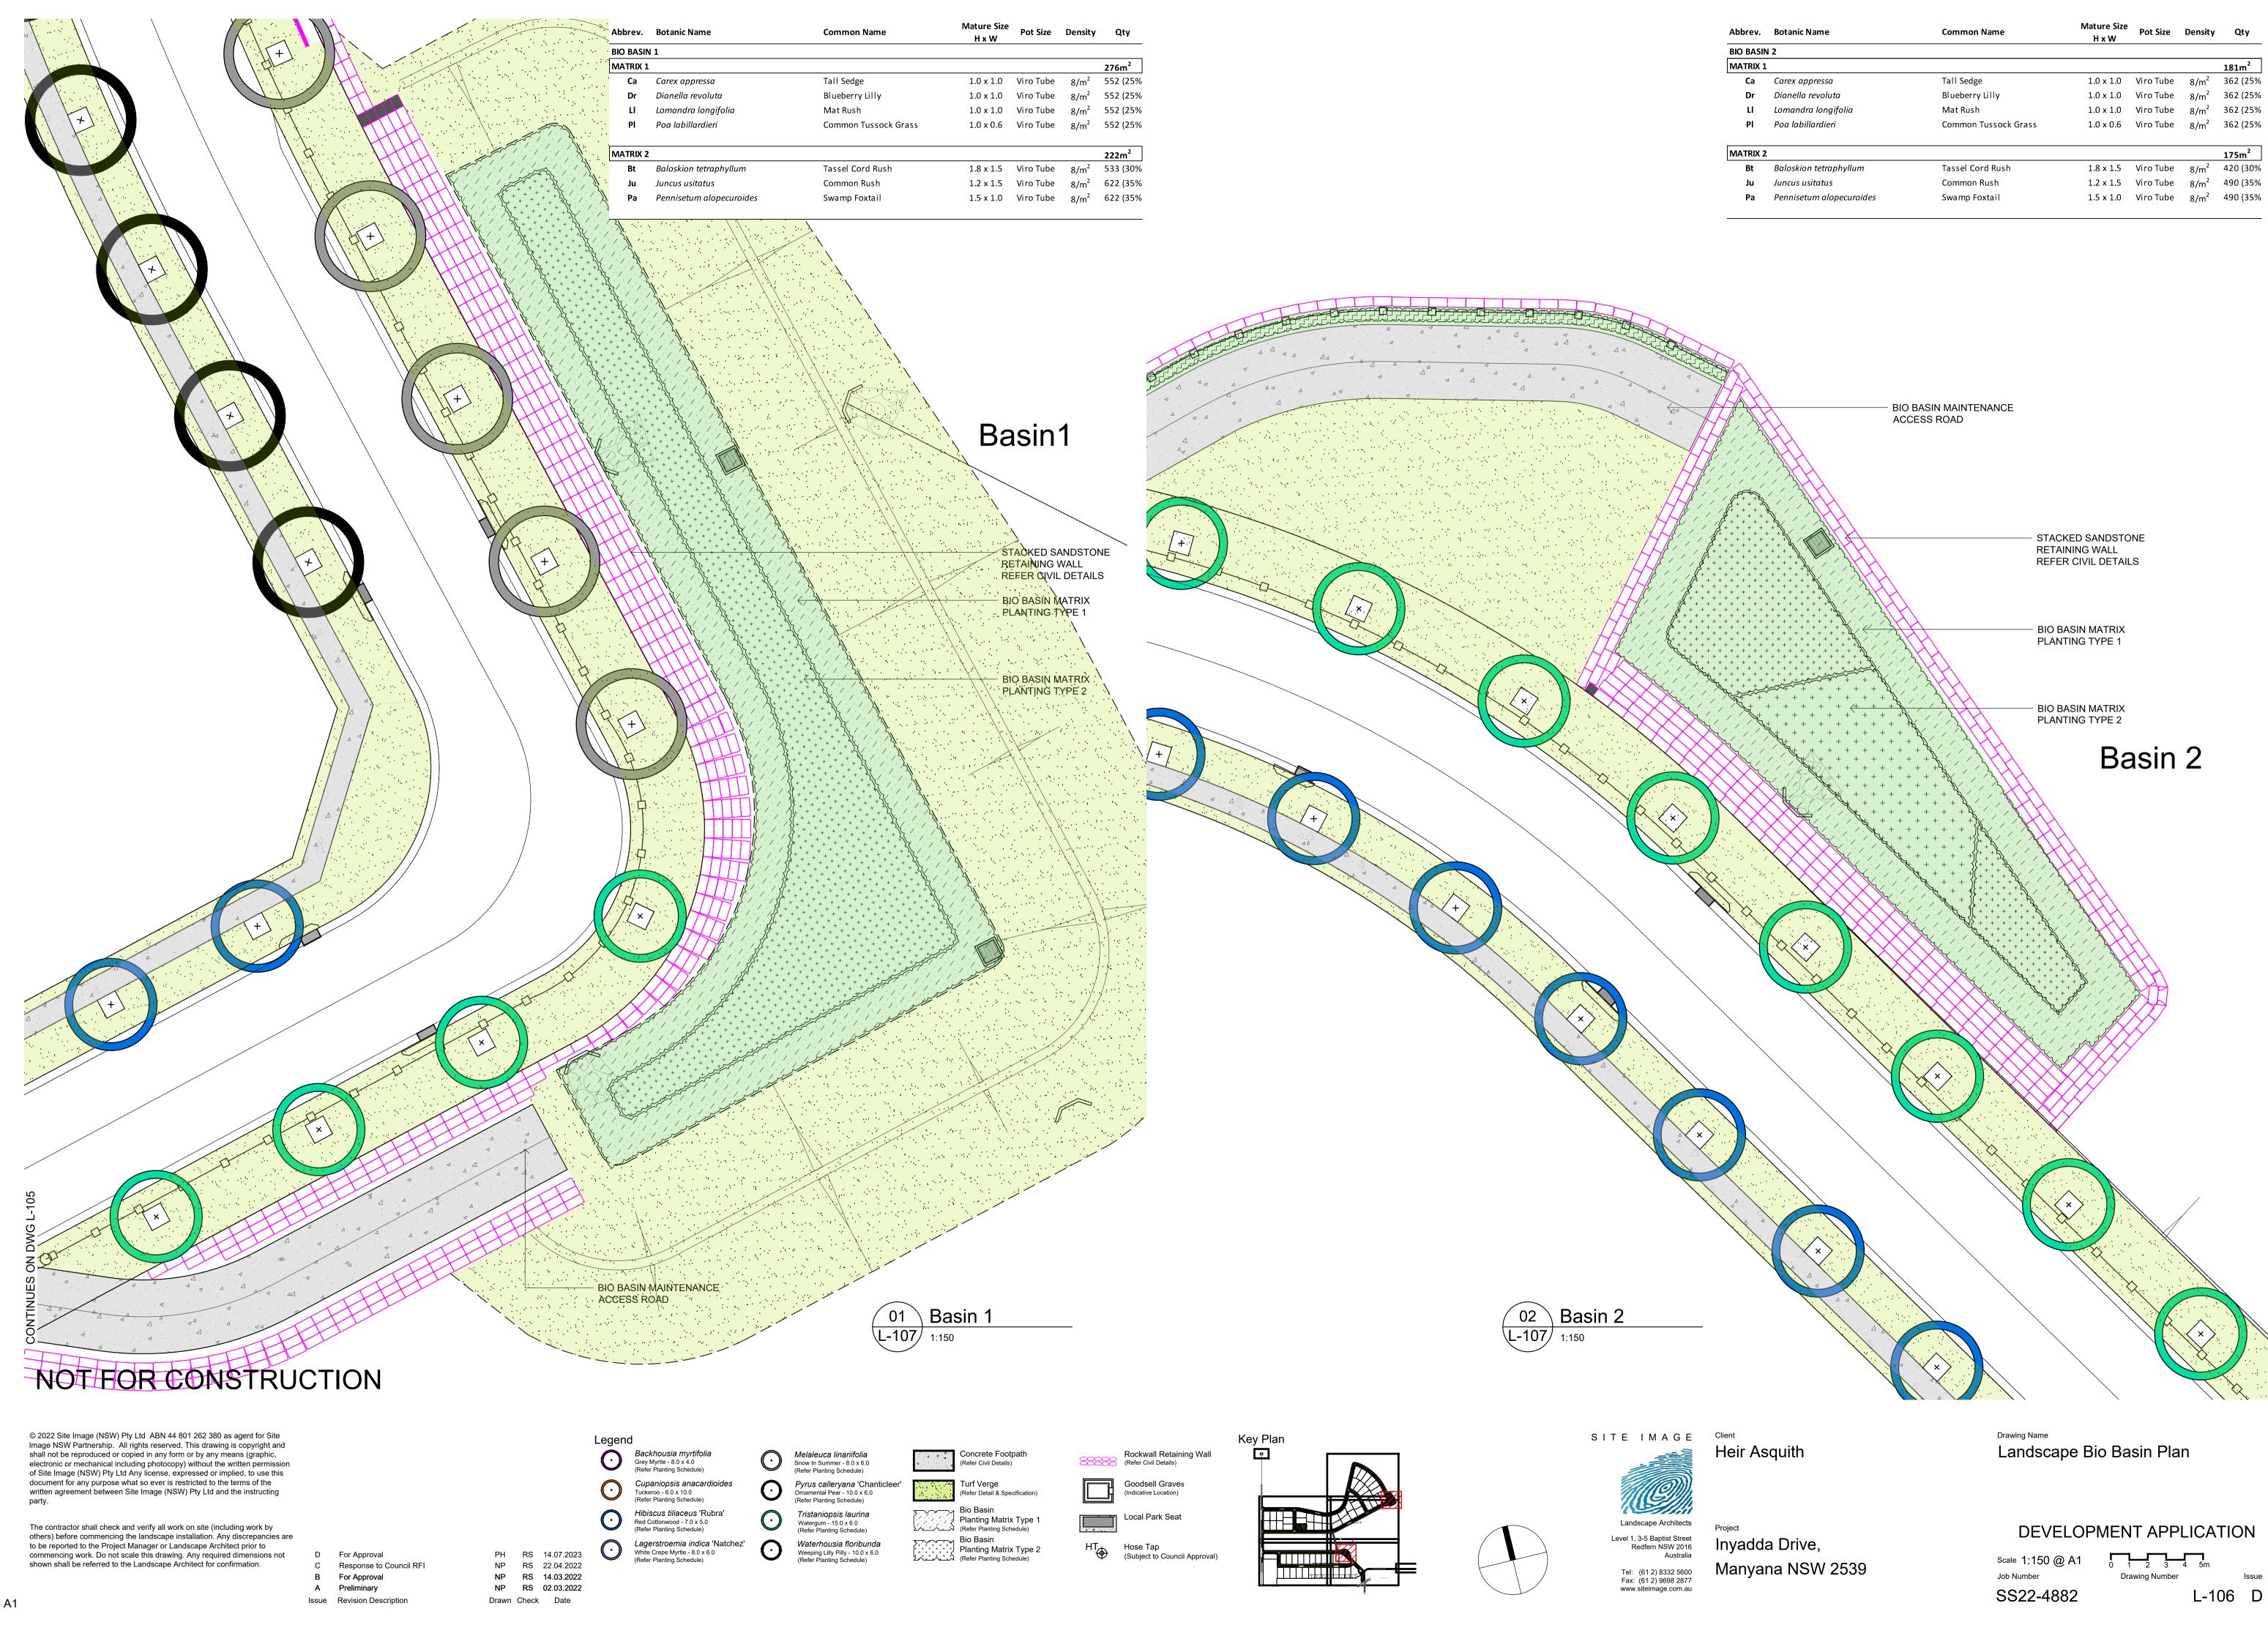

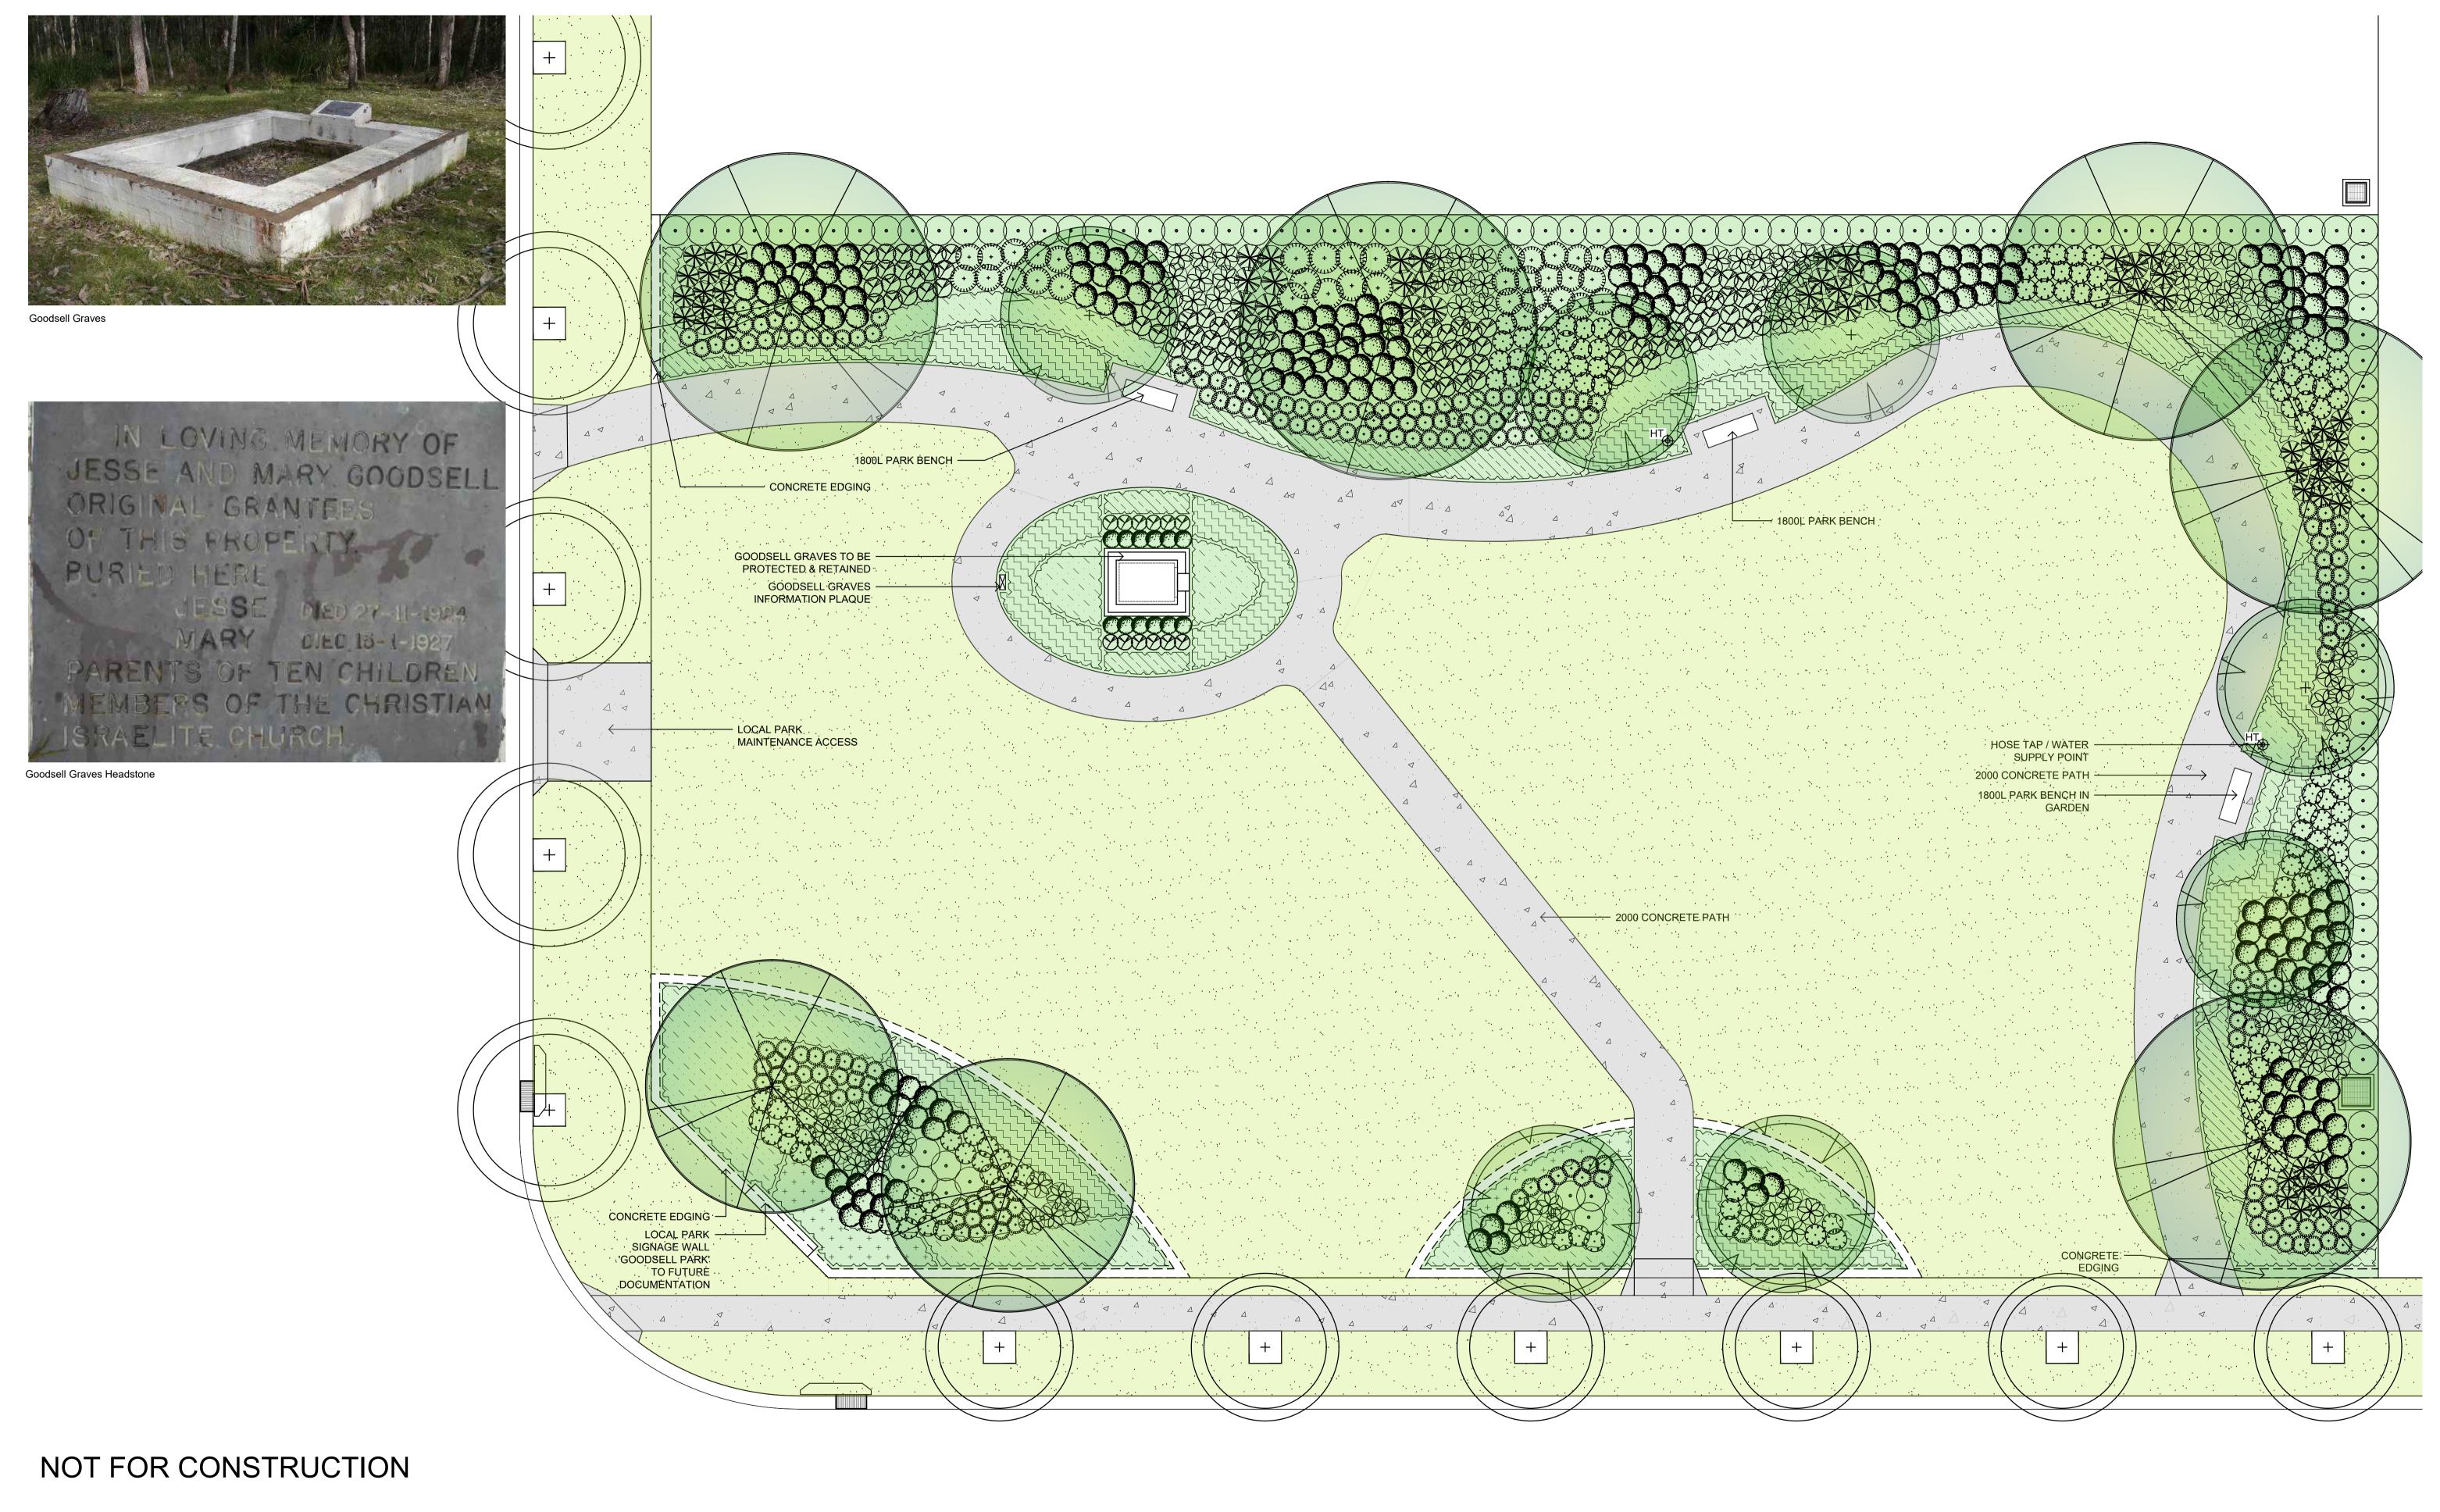

© 2022 Site Image (NSW) Pty Ltd $\,$ ABN 44 801 262 380 as agent for Site Image NSW Partnership. All rights reserved. This drawing is copyright and shall not be reproduced or copied in any form or by any means (graphic, electronic or mechanical including photocopy) without the written permission of Site Image (NSW) Pty Ltd Any license, expressed or implied, to use this document for any purpose what so ever is restricted to the terms of the written agreement between Site Image (NSW) Pty Ltd and the instructing

The contractor shall check and verify all work on site (including work by others) before commencing the landscape installation. Any discrepancies are to be reported to the Project Manager or Landscape Architect prior to commencing work. Do not scale this drawing. Any required dimensions not shown shall be referred to the Landscape Architect for confirmation.

For Approval Response to Council RFI For Approval A Preliminary

PH RS 14.07.2023 NP RS 22.04.2022 NP RS 14.03.2022 NP RS 02.03.2022 Drawn Check Date

Legend Backhousia myrtifolia Grey Myrtle - 8.0 x 4.0 (Refer Planting Schedule) Cupaniopsis anacardioides (Refer Planting Schedule) Hibiscus tiliaceus 'Rubra'


Lagerstroemia indica 'Natchez' White Crepe Myrtle - 8.0 x 6.0

Melaleuca linariifolia Tristaniopsis laurina Watergum - 15.0 x 6.0


Pyrus calleryana 'Chanticleer'

Waterhousia floribunda Weeping Lilly Pilly - 10.0 x 6.0 (Refer Planting Schedule)

Planting Matrix Type 1 (Refer Planting Schedule) Planting Matrix Type 2

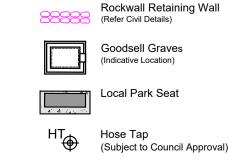



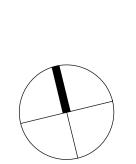

SITE IMAGE Client Landscape Architects Level 1, 3-5 Baptist Street Redfern NSW 2016

Tel: (61 2) 8332 5600

Fax: (61 2) 9698 2877

Heir Asquith


Manyana NSW 2539

Community Park

DEVELOPMENT APPLICATION

Job Number SS22-4882

L-107 D

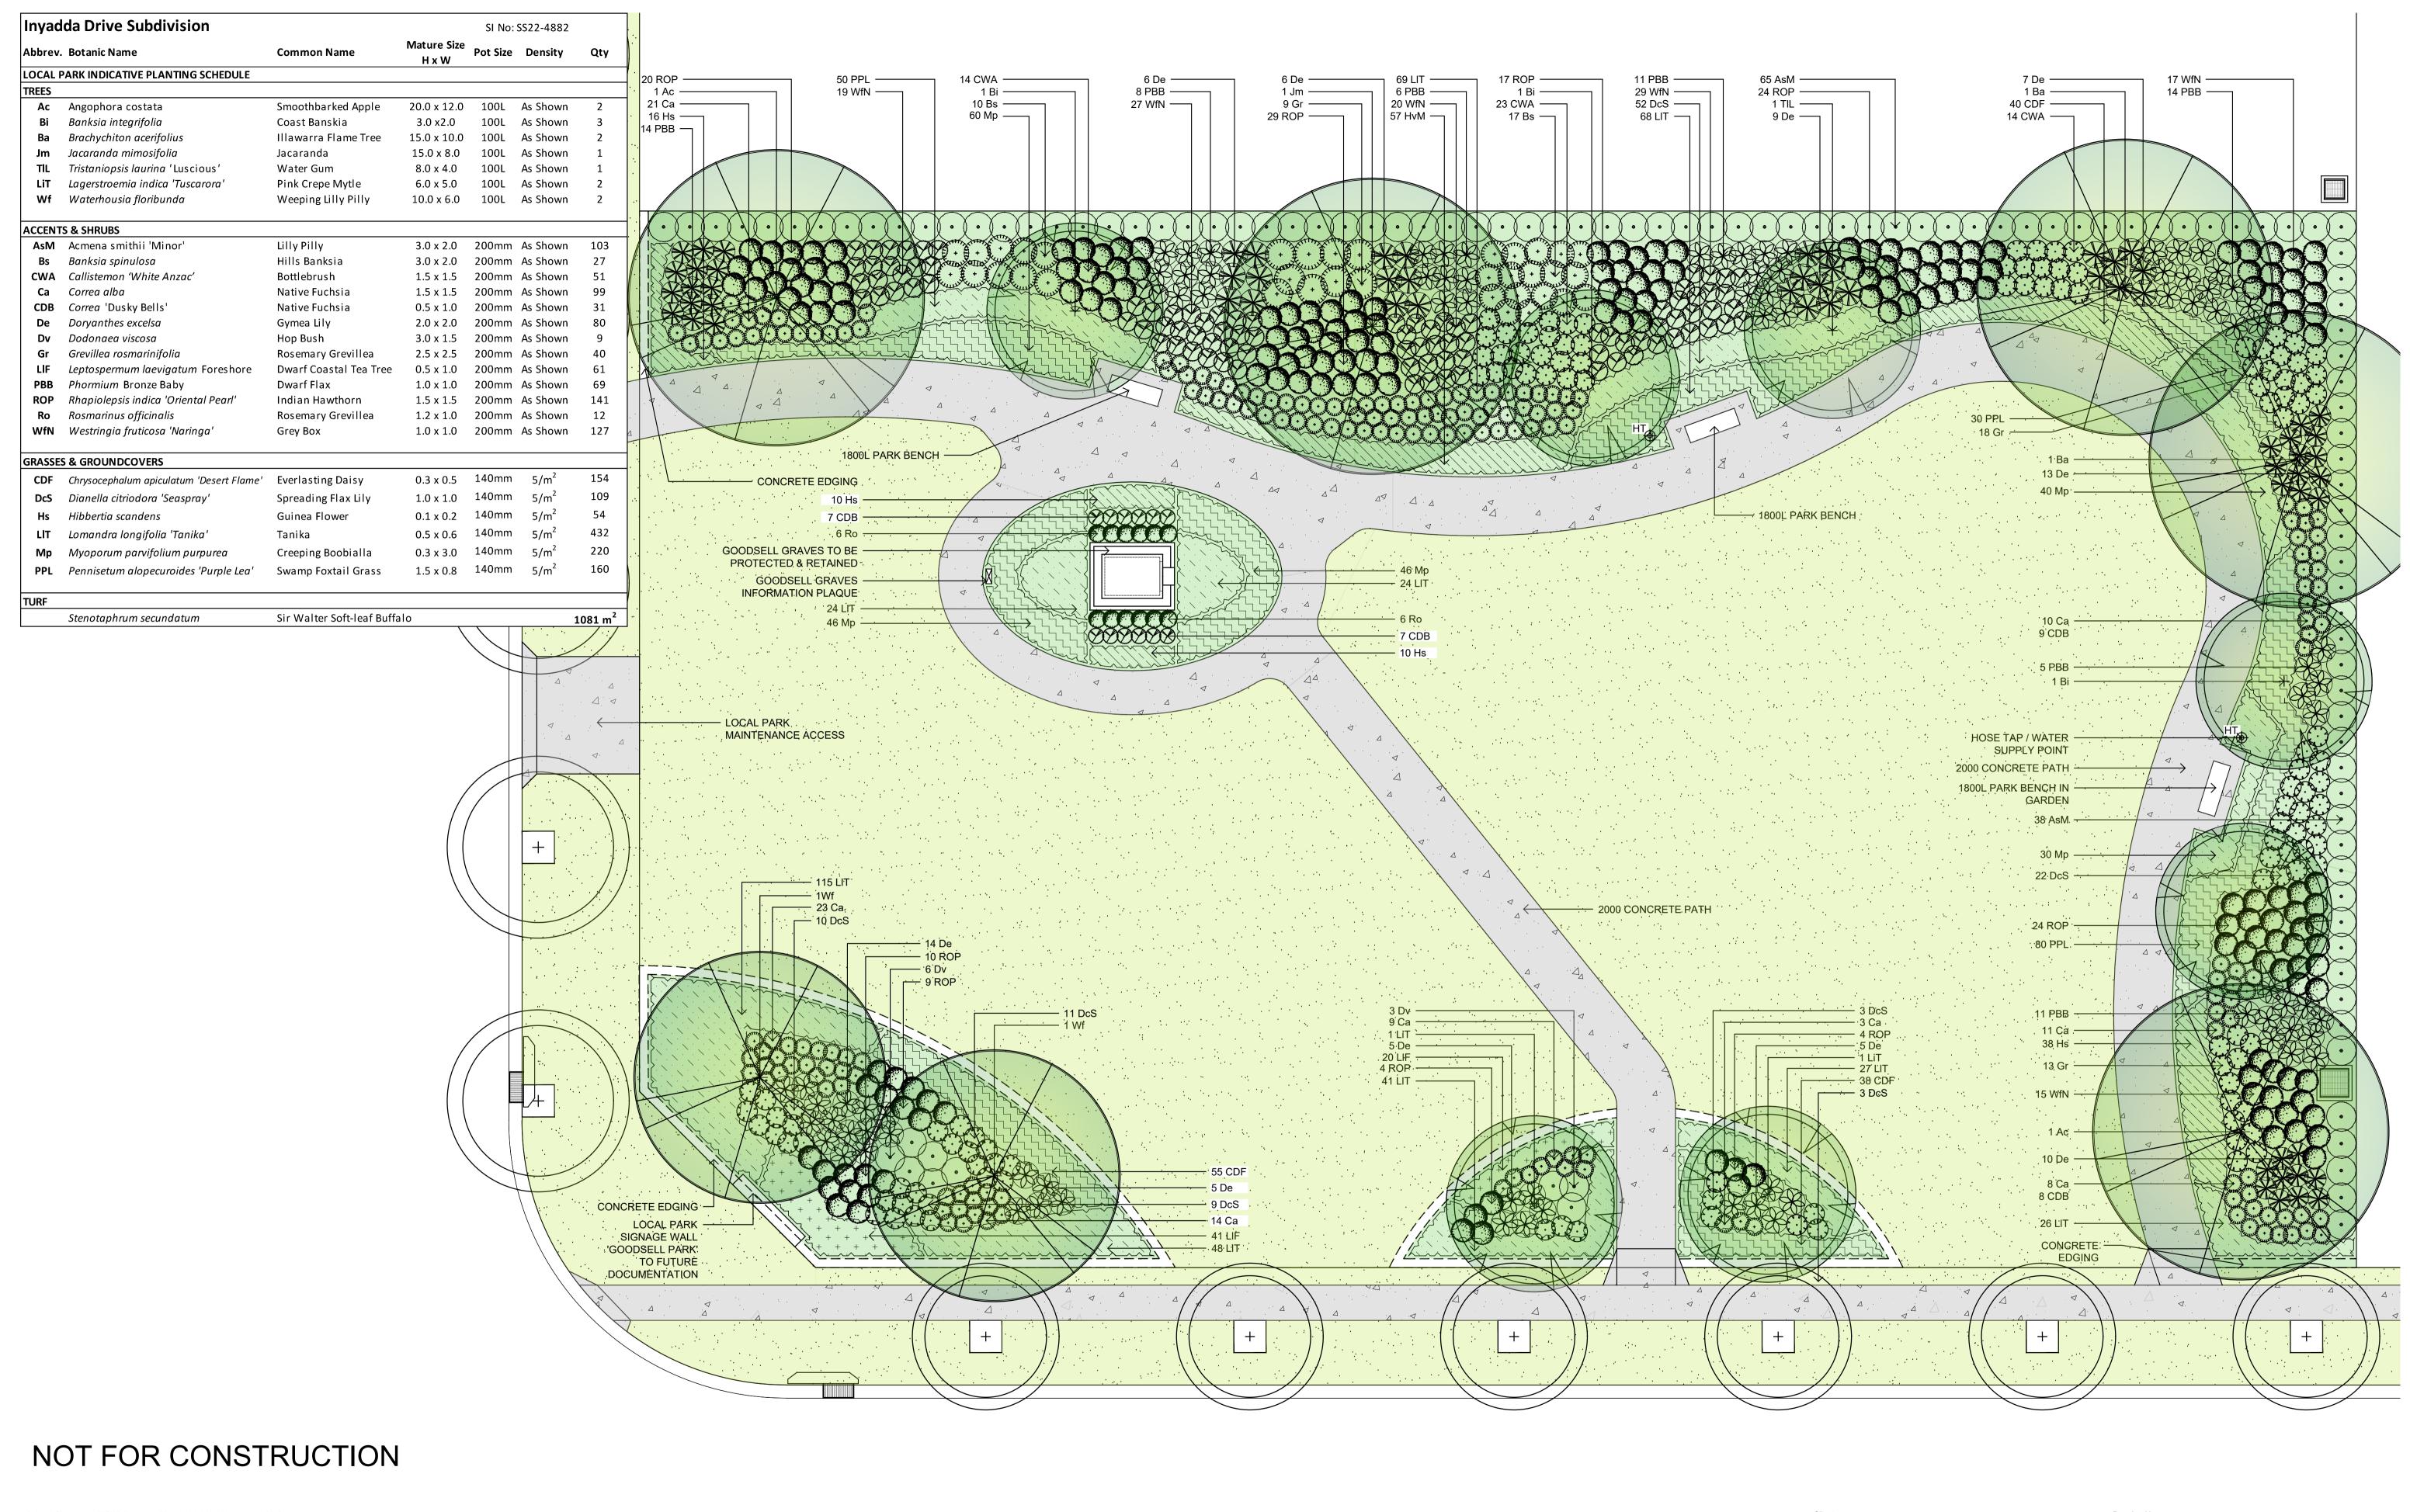

© 2022 Site Image (NSW) Pty Ltd ABN 44 801 262 380 as agent for Site Image NSW Partnership. All rights reserved. This drawing is copyright and shall not be reproduced or copied in any form or by any means (graphic, electronic or mechanical including photocopy) without the written permission of Site Image (NSW) Pty Ltd Any license, expressed or implied, to use this document for any purpose what so ever is restricted to the terms of the written agreement between Site Image (NSW) Pty Ltd and the instructing

The contractor shall check and verify all work on site (including work by others) before commencing the landscape installation. Any discrepancies are to be reported to the Project Manager or Landscape Architect prior to commencing work. Do not scale this drawing. Any required dimensions not

For Approval shown shall be referred to the Landscape Architect for confirmation. For Approval A Preliminary

PH RS 14.07.2023 NP RS 22.04.2022 Response to Council RFI NP RS 14.03.2022 NP RS 02.03.2022 Issue Revision Description Drawn Check Date

Backhousia myrtifolia Grey Myrtle - 8.0 x 4.0 (Refer Planting Schedule) Cupaniopsis anacardioides (Refer Planting Schedule) Hibiscus tiliaceus 'Rubra' Red Cottonwood - 7.0 x 5.0 (Refer Planting Schedule) Lagerstroemia indica 'Natchez' White Crepe Myrtle - 8.0 x 6.0

Legend

Melaleuca linariifolia Snow In Summer - 8.0 x 6.0 Pyrus calleryana 'Chanticleer' Tristaniopsis laurina Watergum - 15.0 x 6.0 Waterhousia floribunda


Weeping Lilly Pilly - 10.0 x 6.0


Local Park Seat Planting Matrix Type 1 (Refer Planting Schedule) Planting Matrix Type 2

(Refer Civil Details)

Goodsell Graves

Hose Tap

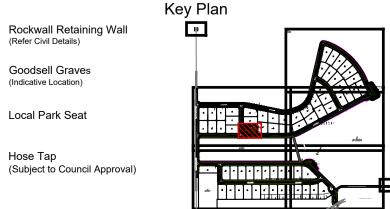

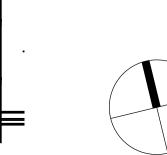

SITE IMAGE Client Landscape Architects Level 1, 3-5 Baptist Street Redfern NSW 2016

Tel: (61 2) 8332 5600

Fax: (61 2) 9698 2877

Heir Asquith

Inyadda Drive, Manyana NSW 2539 Planting Plan - Community Park

DEVELOPMENT APPLICATION

Job Number SS22-4882 L-207 D

SPECIFICATION

GENERAL NOTES

All plans and details included in the project documents shall be read in conjunction with this specification. All structural and civil works components of the landscape design shall be referenced to engineers' details and specifications. Read this specification in conjunction with the plant and materials schedules on the drawings. If in doubt about any detail or if conflicts are found in the documents, seek

Workmanship and Materials

The whole of the landscape works shall be carried out by a competent, trained and qualified landscape contractor who is experienced

• Plants >25 lt: 1 off 38 x 38 x 1200mm; in horticultural practices, landscape construction and planting techniques. The landscape contractor shall hold a current Building

• Semi-advanced plants >75 lt: 2 off 50x50x 1800mm; Contractors License and/or be a financial member of LNA Landscape Association NSW & ACT or equivalent organisations in other

• Advanced plants >100 lt: 3 off 50 x 50 x 2400mm.

EXISTING TREES AND SHRUBS

Trees and Shrubs to be Retained and Protected

Identify and mark trees and shrubs to be retained using a suitable non-injurious, easily visible and removable means of identification. Protect from damage the trees and shrubs to be retained, including those beyond the site area, both above and below the ground. If a • Parallel long sides of level areas, with contours on slopes; and tree becomes damaged during the works or it is proposed to perform work on a tree, give written notice immediately and obtain

• To finish flush, after lightly tamping, with adjacent finished surfaces and design levels.

Work Near Trees and Shrubs

Keep the area of the drip-line free from construction material and debris. Do not place bulk materials and harmful materials under foliage canopies or near trees. Do not place spoil from excavations against tree trunks. Prevent wind-blown building materials, such as

Scope: Unless otherwise noted or instructed irrigate all planted areas shown on plans including planters, tubs, gardens, turf and the cement, from covering trees and other plants. Do not remove topsoil from, or add topsoil to, the area within the drip-line of trees.

EARTHWORKS

Excavation, Trimming and Filling

Except as otherwise noted in the contract, bulk excavation is excluded from the landscape works. After the completion of bulk excavation by others, trim and fill the excavated ground surfaces to achieve design levels to accommodate finish materials as detailed. Prepare the sub-grade surface as required for the various finished ground treatments.

Site Drainage

Keep the excavated works drained and free of standing water. Allow to supply and install sub-soil drainage pipes as required for the new works to ensure that all gardens are well drained. Connect the sub-soil drainage pipes to the nearest downstream stormwater pits. Include pipe filter socks and course sharp aggregate backfilling of trenches.

HARDWORKS

Garden Walls, Fences, Steps, TGSI and Edging

Construct garden walls, fences, steps, TGSI and edging as shown on plan, as detailed and of the material scheduled. Provide footings, step nosings, tactile surfaces to comply with Australian Standards and applicable legislation. Refer to engineer's details for • Replacing failed plants; structural retaining walls, concrete stairs, concrete strength, reinforcing and joint placement.

Continuous, Unit and Loose Pavement

Install the scheduled material pavement to the locations shown on plan. Ensure that all subgrade/subsurface works are complete prior

• Maintaining and removing stakes and ties; to commencing paving. Confer with the engineer to ensure the structural integrity of the subgrade. Ensure that the base course under • Maintaining mulch; paved surfaces is a continuous plane offering a constant depth of bedding material not exceeding 50mm. If laying unit pavers in a • Mowing and top dressing; cement mortar bed on a concrete sub-base ensure that joints in paving match the location of joints in the concrete. Refer to • Irrigation and watering; engineer's details for heavy duty slabs, concrete stairs, concrete strength, reinforcing, and joint type and placement.

Insitu concrete paths: Wood float coved finish, tool edged. • Path joints: Construction joints at 3000mm centres max.

Landscape Structures

All landscape structures shall have a common appearance in detail and material content while providing for the functional design spans and maintain stability. Refer to drawn details for further information.

SOFTWORKS

Site Soil Testing

Where site soil is to be retrieved from site and stored on site for reuse, undertake at least two (2) soil tests in locations as advised by the Project Manager or as shown on the plans. Provide results and recommendations regarding soil additives for the benefit of healthy plant growth and to adjust the soil components to achieve an appropriate planting medium for successful plant development. Where topsoil is imported to site no testing of the imported soil is necessary but ensure that imported soil can be supplied with test data to verify that it suits the design plants.

Excavate and/or fill all garden beds to bring the top of subsoil to at least 300mm below finished design soil levels. Excavate all turf

areas to bring the subsoil to at least 100mm below finished design levels. In all areas shape the subsoil to fall to subsoil drains where applicable. Do not excavate within the drip line of trees and shrubs to be retained. Cultivate or rip the subsoil to a further depth of • if ever possible; 100mm before placing top soil. Remove stones of size exceeding 25mm, clods of earth exceeding 50mm, and weeds, rubbish or other • in wet weather or if wet weather is imminent; deleterious material brought to the surface during cultivation. Do not disturb services or existing tree roots. If necessary, cultivate

• if target plants are still wet after rain; these areas by hand. During cultivation, thoroughly mix in materials required to be incorporated into the subsoil, as recommended in in windy weather; and the soil testing results and to manufacturer's recommendations. Trim the surface to design levels again after cultivation.

the nearest downstream stormwater pit to ensure that subsoil water is managed and channelled to a stormwater drainage system. On control any infestation or disease. Record in the logbook all relevant details of spraying activities including: sites with cross fall of less than 1:50 install subsoil drains to remove excess water from the subsoil in areas where water is likely to

• Product brand / manufacturer's name accumulate and may not penetrate lower strata naturally. Rip the sub-base surface 150mm deep before placing any soil. Install • Chemical / product name, drainage pipes in subsoil trenches backfilled with 10mm blue metal (basalt) equal to ANL Blue Metal.

Coordinate the connection of subsoil drains to stormwater pits with the Civil or Hydraulic contractor.

Import topsoil for the garden and turf areas, unless the topsoil can be provided from material recovered from the site, as recommended in the soil testing results. Spread the topsoil on the prepared subsoil and grade evenly, compact lightly and uniformly in 150mm layers. Avoid differential subsidence and excess compaction and produce a finished topsoil surface which has the following

- Finished to design levels, allowing for mulch or turf, which is to finish flush with adjoining hard surfaces such as paths and edges;
- Smooth and free from inorganic matter, stones or clods of soil; • Graded to drain freely, without ponding, to catchment and/or sub-soil drains;
- Graded evenly to adjoining surfaces; and Ready for planting.

Provide, in accordance with AS 4454, well rotted vegetative material or animal manure, free from harmful chemicals, inorganic matter grass, weeds and the reproductive parts of unwanted plants.

Provide proprietary fertilisers, delivered to the site in sealed containers marked to show manufacturer or vendor, weight, fertiliser type, N:P:K ratio, recommended uses, application rates and safety procedures. Apply appropriate fertiliser suited to the provenance of plants (indigenous or exotic) included in the design.

- Supply plants in accordance with the landscape design drawings and schedules, which have the following characteristics:
- Large healthy root systems, with no evidence of root curl, restriction or damage; • Vigorous, well established, free from disease and pests, of good form consistent with the species/variety;
- Hardened off, not soft or forced, and suitable for planting in the natural climatic conditions prevailing at the site in full sun, partial shade or full shade conditions;
- Grown in final containers for not less than twelve weeks; • Trees, unless required to be multi-stemmed, shall have a single leading shoot; and
- Containers shall be free from weeds and of appropriate size in relation to the specified plant size.

Following excavation of the planting hole, place and spread 15gms of wetting agent pre-mixed with one (1) litre of water. Place the plant correctly orientated to north or for best presentation. Backfill the planting holes with specified topsoil mixture. Lightly tamp and water to eliminate air pockets. Ensure that the backfill soil is not placed over the top of the root ball and that the root ball is not higher than the soil in which it is planted. Apply fertiliser, as specified around the plants in the soil at the time of planting

Embankment Stabilisation

Where necessary and shown on the drawings prevent soil erosion or soil movement by stabilising embankments as follows. As a minimum, this should be on slopes steeper than or equal to 1:3 gradient. Stabilise embankments using biodegradable fibre reinforced heavy weight jute fabric. Lay fabric from top to bottom of slope. Install in accordance with manufacturer's specification, including 300 x 300mm anchor trench at top and bottom of slope, backfilled with soil over the fabric and compacted into the trenches. Using U-shaped galvanised steel pegs at 1000 mm centres generally and 250mm centres at edge overlaps, secure the fabric to the prepared soil surface. Plant through the fabric after it is installed.

Supply and install root control barriers to all new tree plantings adjacent to walls, paths, kerbs and all service trenches, where their proximity poses a threat to the stability of the built infrastructure. Install in accordance with manufacturer's recommendations.

Unless noted otherwise, mulch shall be approved proprietary recycled wood fibre or pine bark material. Place mulch in all garden beds to a depth of 75mm after all specified plants are installed. Keep mulch clear of all plant stems and rake to an even plane, flush with the surrounding surfaces evenly graded between design surface levels. Over fill to allow mulch to settle to the specified depth.

Stakes shall be durable hardwood, straight, free of knots and twists, pointed at one end, in the following quantities and sizes for each

- of the various plant pot sizes:

Turf shall be delivered to site as 25mm minimum thick cut rolls. Obtain turf from a specialist grower of cultivated turf. Turf shall have an even thickness, free from weeds and other foreign matter. Deliver turf to the site within 24 hours of being cut and lay it within 24 hours

- of delivery. Prevent it form drying out between cutting and laying. Lay the turf in the following manner:
- In stretcher pattern, joints staggered and close butted;
- Species: Stenotaphrum secundatum Sir Walter Soft-leaf Buffalo.

like. The irrigation system shall be an automatic permanent system, with an irrigation controller self operated via a soil moisture sensor. The system shall be calibrated to deliver the optimum rate and volume of water appropriate to the type of plants in the design. The system shall be adjustable and fully serviceable. The layout of the entire irrigation system shall focus on delivering the required amount of water to maintain healthy and vigorous growth. The irrigation system shall be such that, component theft, vandalism, over-spray and wetting of paths shall be reduced to a minimum or eliminated with the use of drip, pop-up sprinklers and judiciously placed fixed spray emitters. Generally, do not use fine mist emitters that provide a drifting mist that may wet paths and the buildings unless specifically required by the design.

The Landscape Contractor shall engage a qualitied irrigation consultant to design the system, document all components, accessories and materials for review by the Landscape Architect prior to starting landscape works generally.

LANDSCAPE MAINTENANCE

The Landscape Contractor shall rectify defects during installation and that become apparent in the works under normal use for the duration of the contract Defects Liability Period. Unless contracted otherwise, the Landscape Contractor shall maintain the contract areas by the implementation of industry accepted horticultural practices for 52 weeks from Practical Completion of the works. The landscape maintenance works shall include, but not be limited to:

- Pruning;
- Insect and pest control:

Fertilising;

- Erosion control; and Weeding and rubbish removal

Implement and keep a maintenance log book recording when and what maintenance work has been undertaken and what materials. actions and decisions have been used, implemented and concluded to keep the landscape always looking its best. Enter data daily requirements. The structure of all elements shall consist of a base frame of structural grade hardwood timber of sizes that sustain and review information every 2 weeks. Observe trends and develop a maintenance regime around seasonal and observed event

During the defect maintenance period schedule the following activities to occur on a timely basis.

Plant replacement - Replace plants that have failed to mature, die or are damaged. Replacement plants shall be in a similar size and quality and identical species or variety to the plant that has failed. Replacement of plants shall be at the cost of the landscape contractor unless advised otherwise. If the cause of the failure is due to a controllable situation then correct the situation prior to replacing plants. Observe and replace failed plants within 2 weeks of observation.

Pruning - Prune dead wood, broken limbs, dead or infected foliage and as needed to develop strong, healthy plants to achieve the shape and form expected of the plant type. Observe daily and prune plants as necessary to maintain acceptable growth habit.

Insect, disease and pest control - Avoid spraying:

- if non-target species are too close.

Immediately report to the Project Manager any evidence of intensive weed infestation, insect attack or disease amongst plant material. Provide and install subsoil drainage equal to Vinidex 65mm (min) Draincoil with filter sock at the base of slopes, on the high side of

Submit all proposals to apply chemicals and obtain approval before starting this work. When approved, spray with herbicide. paths, at the base behind retaining walls and where water is likely to accumulate at depth in the soil. Connect all subsoil drainage to insecticide, fungicide as appropriate in accordance with the manufacturers' recommendations. Observe daily and act as necessary to

- Application quantity and rate, • Date of application and location.
- Results of application, and Use approval authority.

Fertilise gardens with a proprietary slow release fertiliser applied in accordance with the manufacturer's directions and recommendations. Apply 6-12 monthly. Record in the logbook all relevant details of fertilising including:

- Product brand / manufacturer's name,
- Fertiliser / product name,
- Application quantity and rate, and Date of application and location.

Stakes and ties - Adjust and replace as required to ensure plants remain correctly staked. Remove those not required at the end of the planting establishment period (Defects Liability Period). Inspect and act at least every 2 weeks.

Maintaining mulch - Maintain the surface in a clean, tidy and weed free condition and reinstate the mulch as necessary to ensure correct depth as specified. Observe weekly and replenish mulch as required.

Mowing and top dressing - Mow the turf to maintain a grass height of between 30-50mm. Do not remove more than one third of the grass height at any one time. Remove grass clippings from the site after each mowing. Top dress to a maximum of 10mm to fill depressions and hollows in the surface. Mow weekly/fortnightly in warmer months. Mow monthly or as required in cooler months. Top dress at approximately 6 monthly intervals.

Irrigation and watering - Maintain the irrigation system to sure that each individual plant receives the required amount of water to maintain healthy and vigorous growth. Adjust and calibrate as required. Provide additional watering, if necessary but inspect irrigation weekly and make repairs as necessary.

Erosion control - Where necessary, maintain the erosion control fabric in a tidy and weed free condition and reinstate as necessary to ensure control measures are effective where deemed necessary. Inspect every 2 weeks and act to repair any damage as soon as

Weeding and rubbish removal - During the plant establishment period remove by hand, rubbish and weed growth that may occur or re-occur throughout all planted, mulched and paved areas. The contractor shall target weeds that are capable of producing a major infestation of unwanted plants by seed distribution. Whenever possible, time weed removal to precede flowering and seed set. Constant observation and removal of weeds is essential.


NOT FOR CONSTRUCTION


© 2022 Site Image (NSW) Pty Ltd ABN 44 801 262 380 as agent for Site Image NSW Partnership. All rights reserved. This drawing is copyright and shall not be reproduced or copied in any form or by any means (graphic, electronic or mechanical including photocopy) without the written permission of Site Image (NSW) Ptv Ltd Any license, expressed or implied, to use this document for any purpose what so ever is restricted to the terms of the written agreement between Site Image (NSW) Pty Ltd and the instructing

The contractor shall check and verify all work on site (including work by others) before commencing the landscape installation. Any discrepancies are to be reported to the Project Manager or Landscape Architect prior to commencing work. Do not scale this drawing. Any required dimensions not shown shall be referred to the Landscape Architect for confirmation.


- Response to Council RFI For Approval
- A Preliminary
- NP RS 14.03.2022 NP RS 02.03.2022 Drawn Check Date

NP RS 22.04.2022

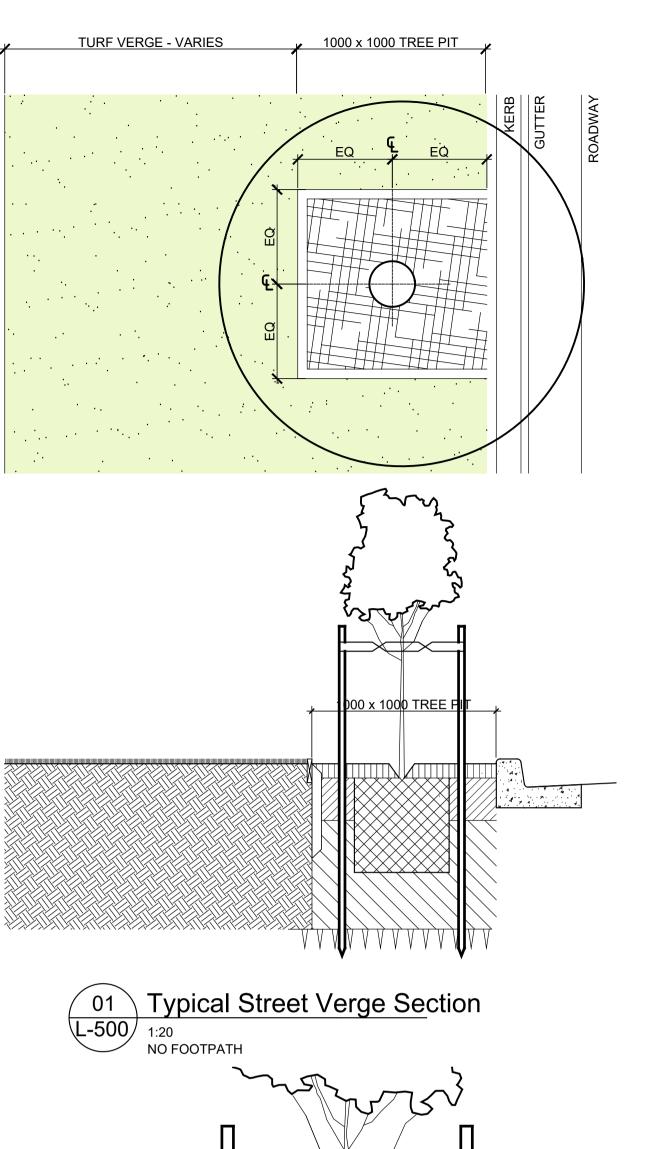

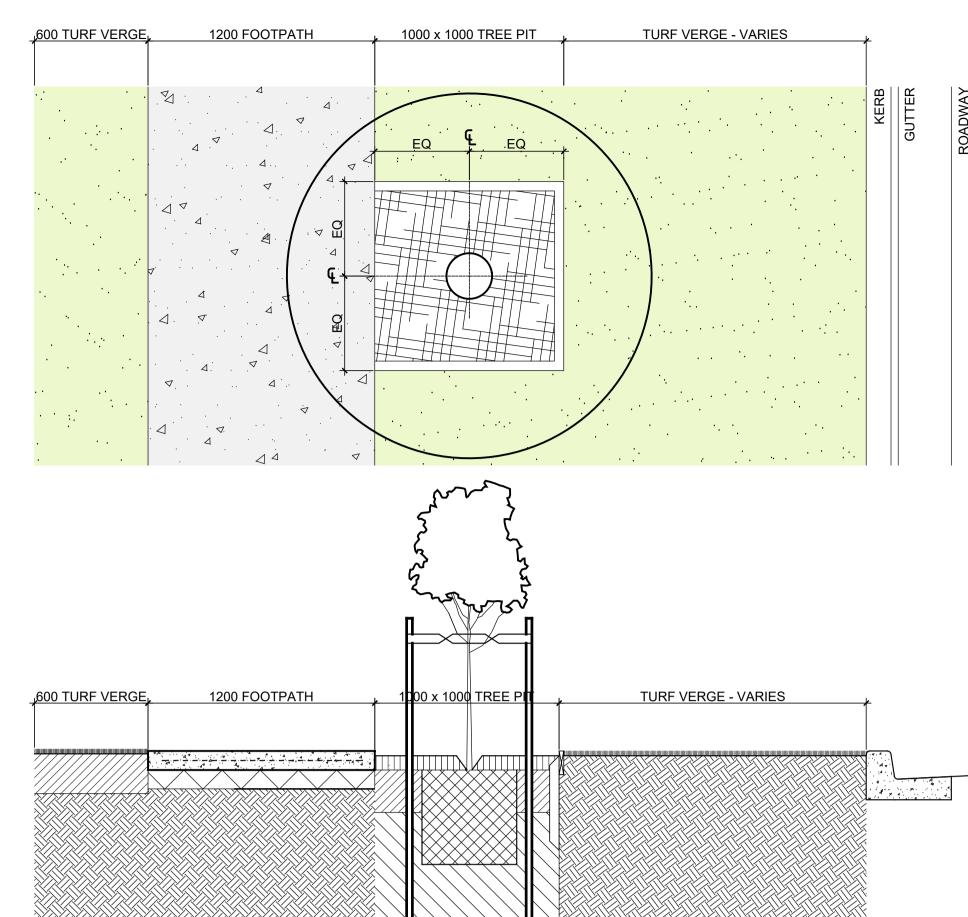

02 \ Typical Street Verge Section

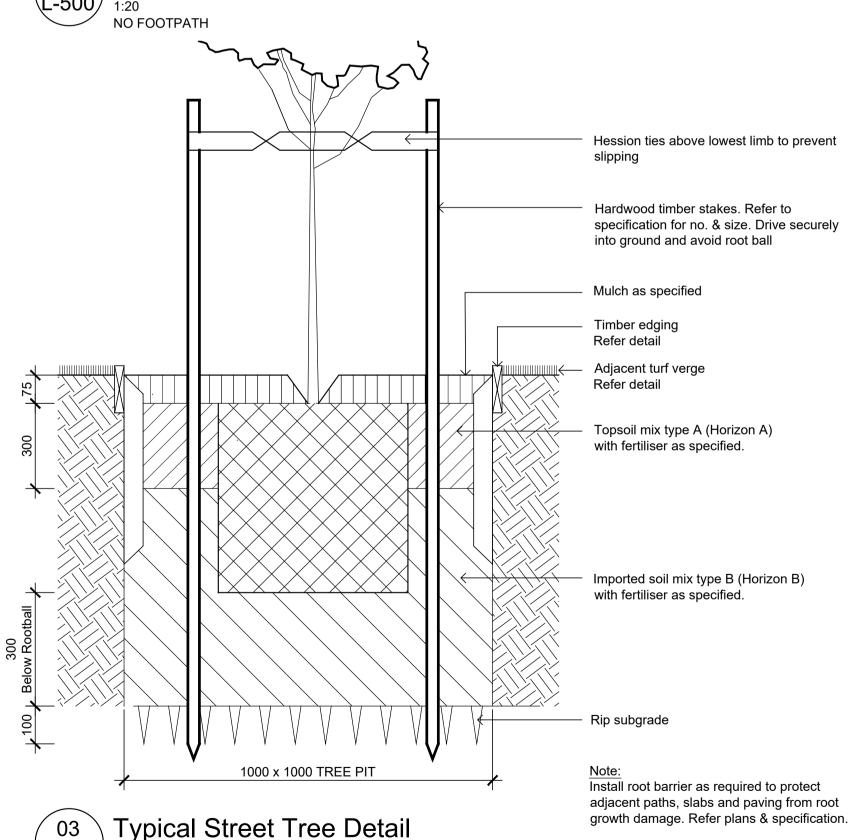

SITE IMAGE Client Landscape Architects Level 1, 3-5 Baptist Street Redfern NSW 2016

Heir Asquith

Invadda Drive, Manyana NSW 2539 Tel: (61 2) 8332 5600 Fax: (61 2) 9698 2877


Landscape Specification Notes & **Typical Street Tree Sections**

DEVELOPMENT APPLICATION


Scale 1:10 @ A1 & 1:20 @ A1 **Drawing Number**

L-500 D


SS22-4882 Issue Revision Description

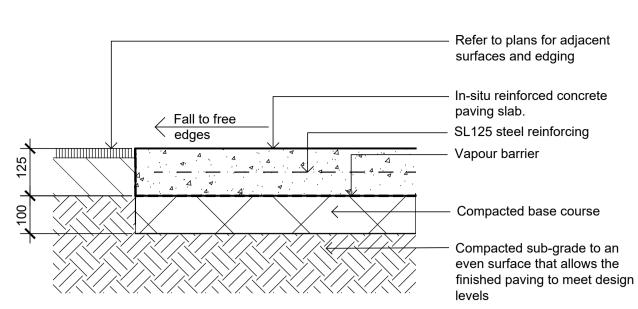


01 Insitu Concrete Paving - On grade
L-501 1:10

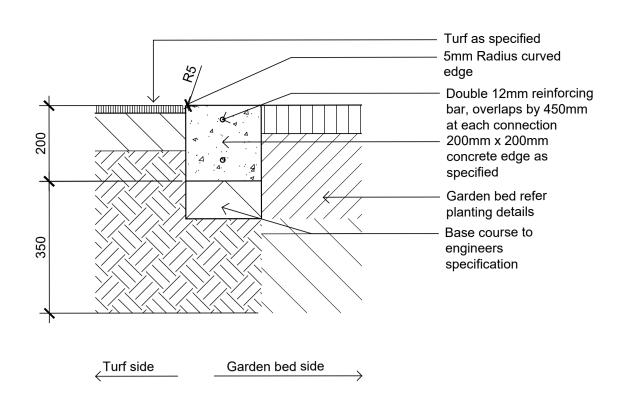

Typical Concrete Edge 04 Typ

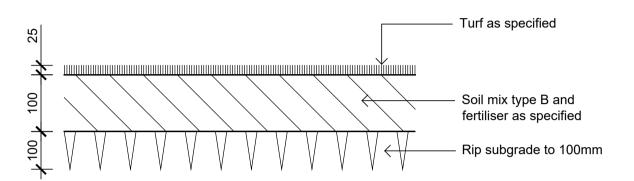


02 Detail Turf on Even Grade L-501 1:10

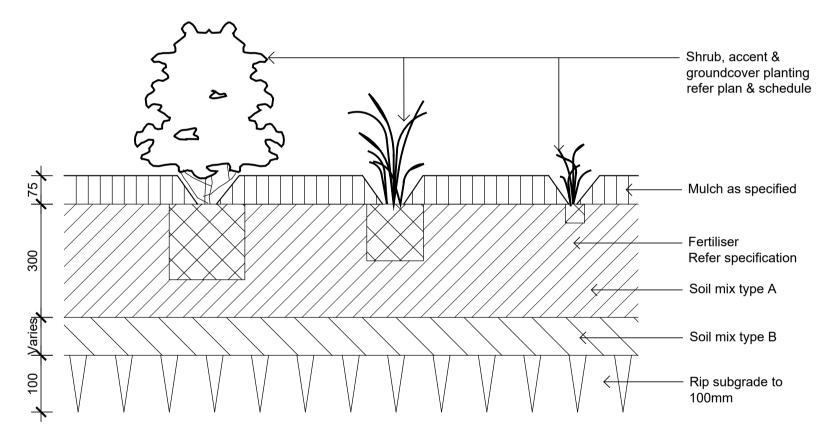

03 Detail Shrub Accent & Groundcover Planting on Grade L-501 1:10

75mm Mulch Refer specification 500 300mm Top soil mix type A Refer specification Sandstone log retaining wall Refer civil details Compacted low permeability clay Refer civil details & specification Concrete cut off infill wall Refer civil details & specification

05 Typ L-501 1:20 Typical Indicative Back to Back Retaining Walls

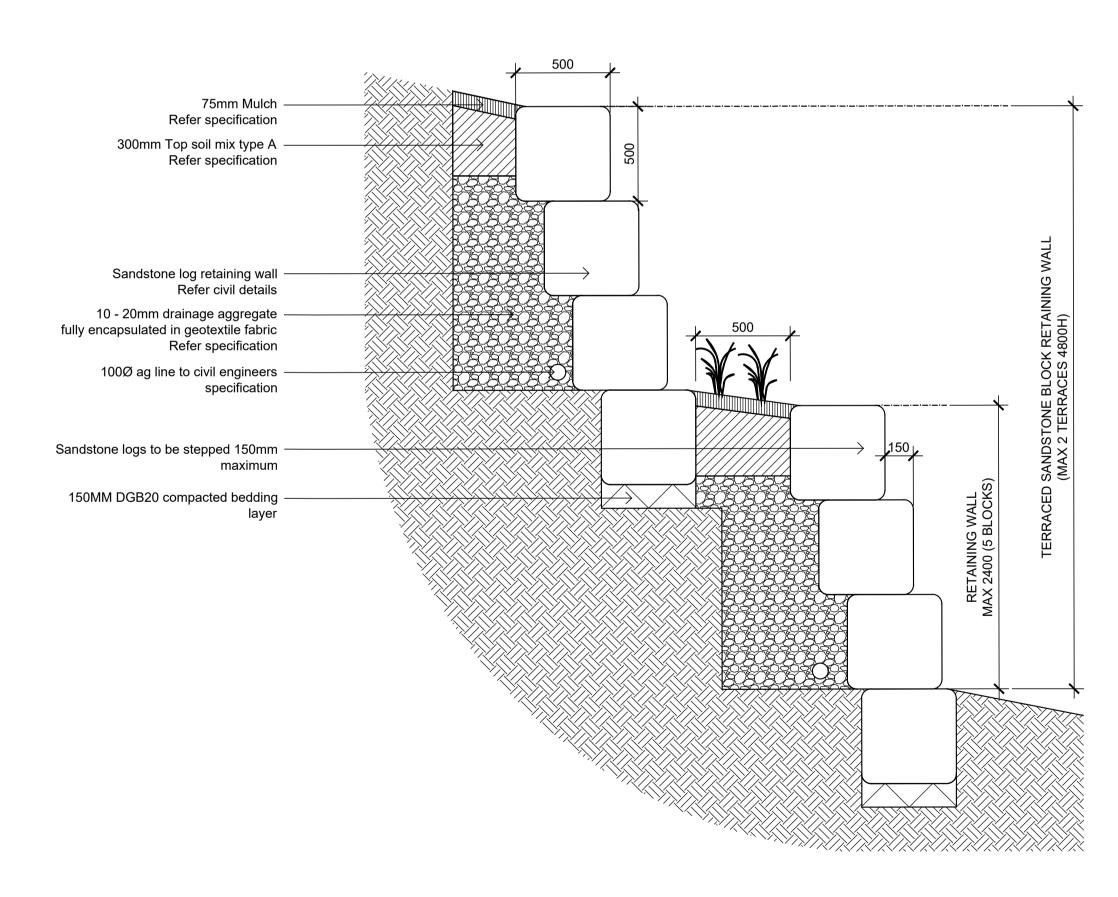

106 Typical Terraced Sandstone Block Wall L-501 1:20

NOT FOR CONSTRUCTION

© 2022 Site Image (NSW) Pty Ltd $\,$ ABN 44 801 262 380 as agent for Site Image NSW Partnership. All rights reserved. This drawing is copyright and shall not be reproduced or copied in any form or by any means (graphic, electronic or mechanical including photocopy) without the written permission of Site Image (NSW) Pty Ltd Any license, expressed or implied, to use this document for any purpose what so ever is restricted to the terms of the written agreement between Site Image (NSW) Pty Ltd and the instructing

The contractor shall check and verify all work on site (including work by others) before commencing the landscape installation. Any discrepancies are to be reported to the Project Manager or Landscape Architect prior to commencing work. Do not scale this drawing. Any required dimensions not

shown shall be referred to the Landscape Architect for confirmation.

For Approval Response to Council RFI B For Approval A Preliminary Issue Revision Description

PH RS 14.07.2023 NP RS 22.04.2022 NP RS 14.03.2022 NP RS 02.03.2022 Drawn Check Date

Legend

Key Plan



Heir Asquith


Inyadda Drive, Manyana NSW 2539 Tel: (61 2) 8332 5600 Fax: (61 2) 9698 2877


Landscape Details

DEVELOPMENT APPLICATION


Scale 1:10 @ A1 Job Number

L-501 D SS22-4882

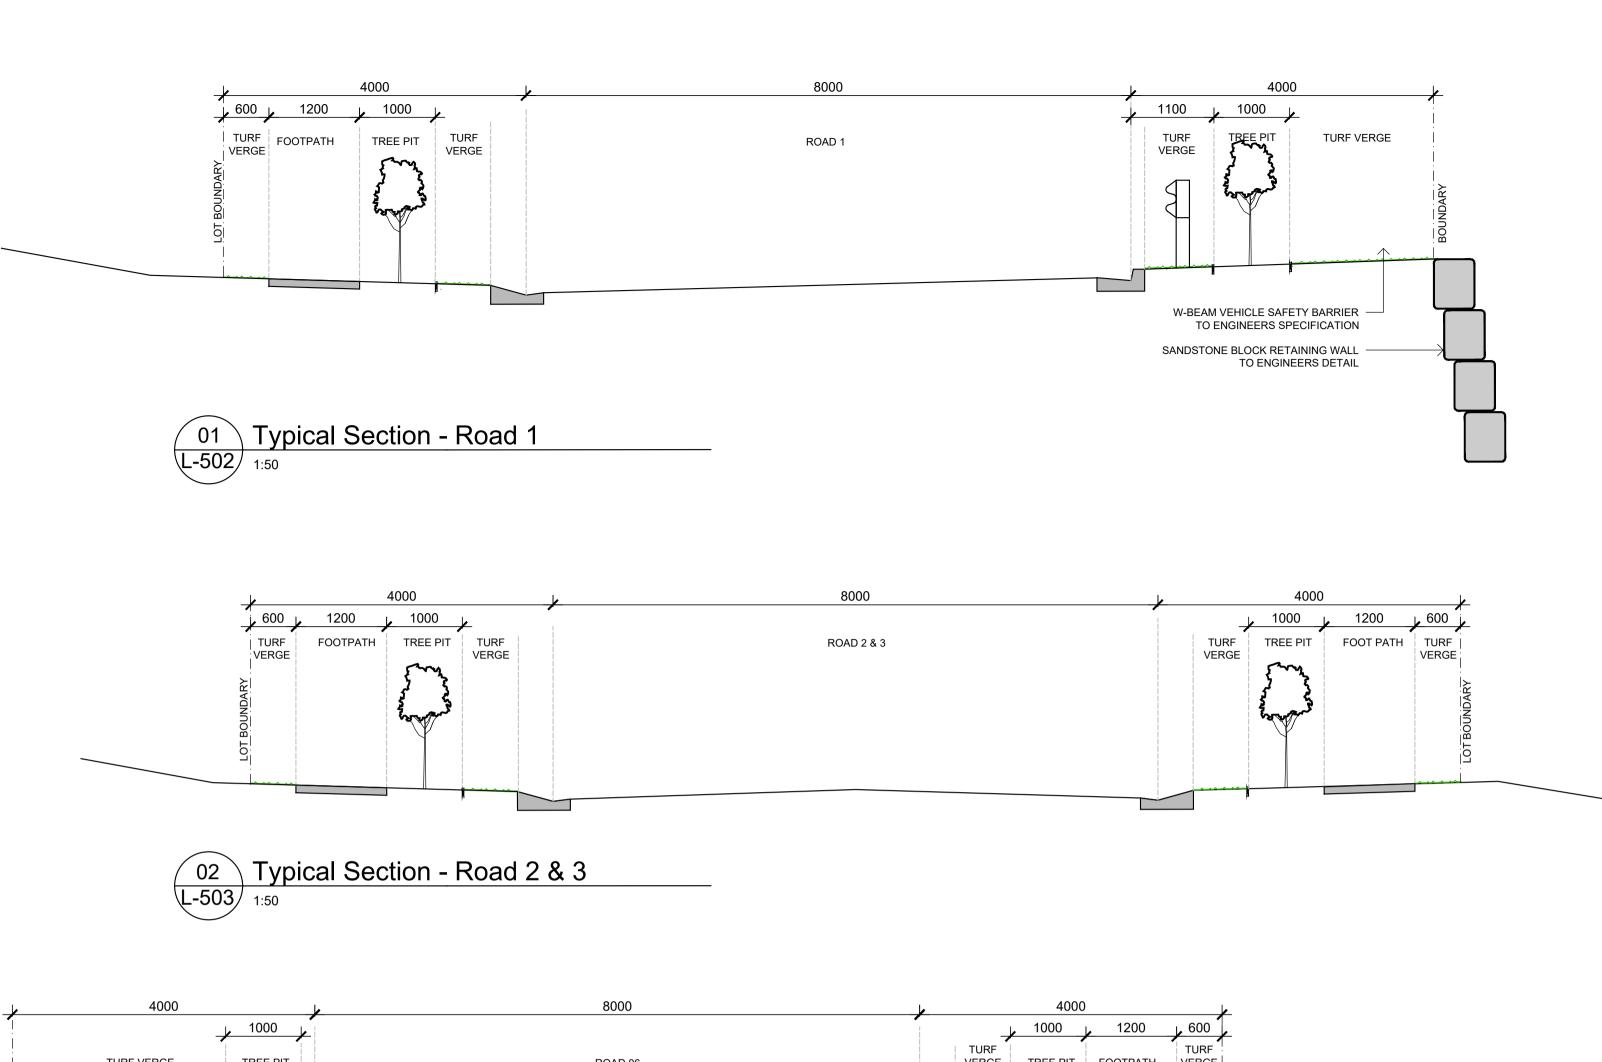

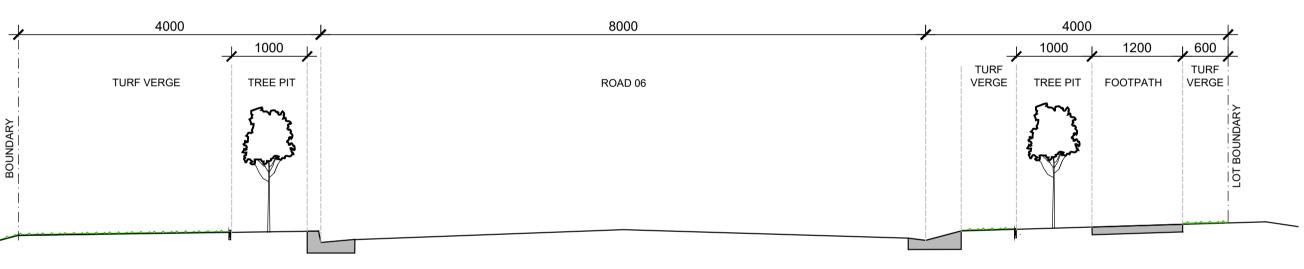

Typical Section - Road 6 L-502 1:50

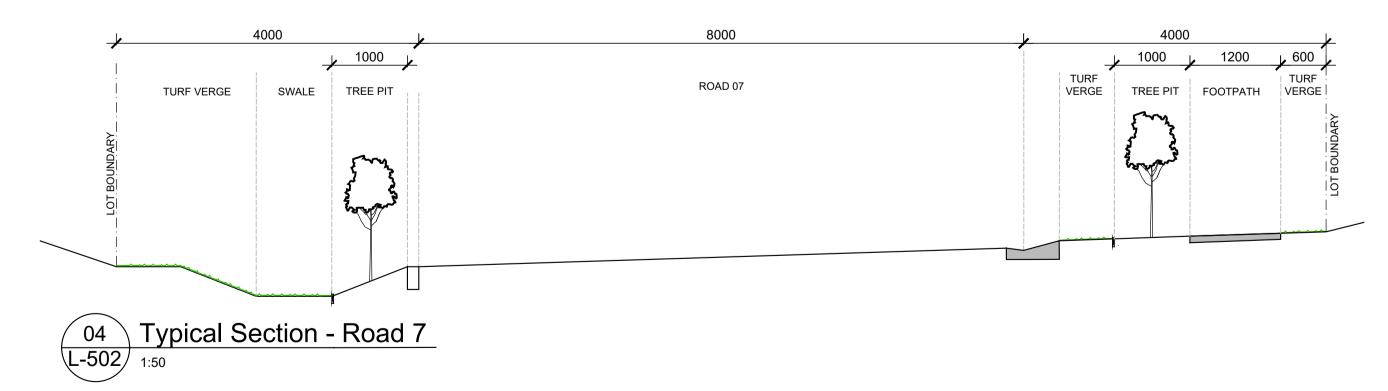

Legend

NOT FOR CONSTRUCTION


© 2022 Site Image (NSW) Pty Ltd ABN 44 801 262 380 as agent for Site Image NSW Partnership. All rights reserved. This drawing is copyright and shall not be reproduced or copied in any form or by any means (graphic, electronic or mechanical including photocopy) without the written permission of Site Image (NSW) Pty Ltd Any license, expressed or implied, to use this document for any purpose what so ever is restricted to the terms of the written agreement between Site Image (NSW) Pty Ltd and the instructing

The contractor shall check and verify all work on site (including work by others) before commencing the landscape installation. Any discrepancies are to be reported to the Project Manager or Landscape Architect prior to commencing work. Do not scale this drawing. Any required dimensions not shown shall be referred to the Landscape Architect for confirmation.

For Approval Response to Council RFI B For Approval A Preliminary

PH RS 14.07.2023 NP RS 22.04.2022 NP RS 14.03.2022 NP RS 02.03.2022

Key Plan

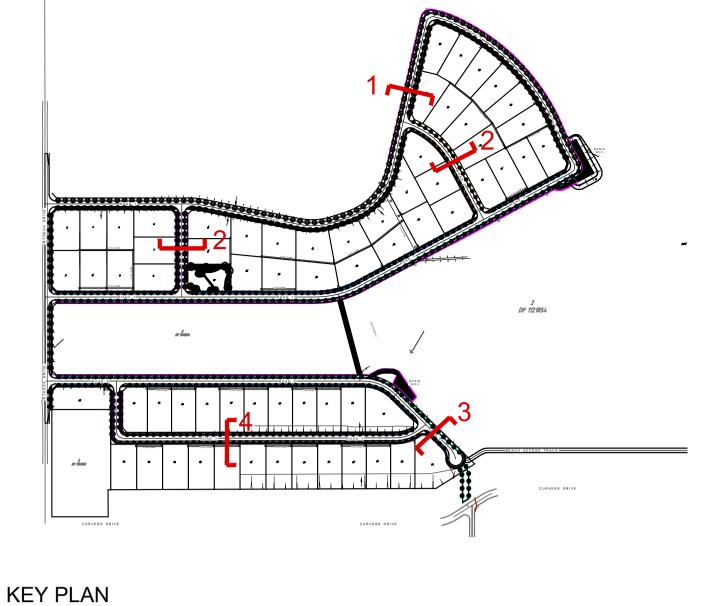





Fax: (61 2) 9698 2877

Heir Asquith

Inyadda Drive, Manyana NSW 2539 Landscape Typical Road Sections

DEVELOPMENT APPLICATION

Scale 1:10 @ A1 Job Number

Drawing Number SS22-4882 L-502 D

Issue Revision Description Drawn Check Date